

NOTICE OF PLAN COMMISSION MEETING

DATE: Tuesday, August 12, 2025

TIME: 5:15pm

LOCATION: Combined Locks Civic Center, Council Chambers, 405 Wallace Street

AGENDA

- 1. Review and consider approval of minutes from 06/10/25 meeting
- 2. Review plans for Culver's Office Building on lot 10 in The Locks Business Park; recommendation
- 3. Discuss potential for mountain bike trail at Lindberg Park with members of NEWT/MTN bike community
- 4. Review updated format of 5-Year Comprehensive Outdoor Recreation Plan & provide feedback
- 5. Schedule next meeting may include park/trail tours
- 6. Adjourn

Public Notice: Agendas are posted in the following locations: Combined Locks Civic Center main entrance and Village website: www.combinedlocks.wi.gov. 2015
Wisconsin Act 79 allows the publication of certain legal notices on an internet site maintained by a municipality. This law allows these types of legal notices to be posted in one physical location in the jurisdiction (instead of three) if also placed on an internet site maintained by the local government.

Special Accommodations: Requests from persons with disabilities who need assistance to participate in this meeting or hearing should be made with as much advance notice as possible to the Clerk's Office at 405 Wallace Street, 920-788-7740 extension 203 or email at gieser@combinedlocks.wi.gov.

Notice of Possible Quorum: A quorum of the Village Board, Zoning Board of Appeals, or other Village committee may be present at this meeting for the purpose of gathering information and possible discussion on items listed on this agenda. However, unless otherwise noted in this agenda, no official action by the Village Board, Board of Review, Zoning Board of Appeals, or other Village committee will be taken at this meeting.



MINUTES OF PLAN COMMISSION MEETING

DATE: Tuesday, June 10, 2025

TIME: 5:15pm

LOCATION: Combined Locks Civic Center, Trail Entrance by Horseshoe Court,

405 Wallace Street

MINUTES

A. Call to order: Meeting called to order at 5:20pm.

B. Attendance: Plan Commission members present – Mulry, Carney, Mader, Maynard, Talbot, and Romberg. Plan Commission members absent – Heckner & Weyenberg. Staff present – Administrator Shampo-Giese. Others present – none

- **1. Review and consider approval of minutes from 05/13/25 meeting:** K. Carney made a motion to approve the minutes as presented. N. Romberg seconded the motion, and it passed unanimously.
- 2. Tour trails in Memorial Park and Lindberg Park as part of Comprehensive Outdoor Recreation Plan updates: Commission members toured the trails and noted conditions, short-term improvements, long-term improvements, tree removals and plantings, potential safety features, and visibility of the trails from various points along Memorial Park and Lindberg Park. Colored trail markers for emergency response, moving the ice rink to the bottom of the sled hill, moving park and trail signs for better visibility, adding a small amphitheater with restrooms, and a mountain bike trail were all added to the list of potential future improvements. It was noted that Lindberg Park has a large amount of underutilized space that could be improved for active and passive activities.
- 3. Schedule next meeting may include park/trail tours: The next meeting is scheduled for 5:15pm on 08/12/25.
- **4. Adjourn: K.** Carney made a motion to adjourn the meeting. RJ Talbot seconded the motion, and it passed unanimously. The meeting adjourned at 6:56pm.

1250 Centennial Centre Blvd Hobart, WI 54155 920-662-9641 releeinc.com

June 25, 2025

Ms. Racquel Shampo-Giese
VILLAGE OF COMBINED LOCKS
405 Wallace Street
Combined Locks, WI 54113

RE:

Site Plan Application - Culver's Regional Office Building

Dear Ms. Shampo-Giese:

On behalf of Bayland Buildings, Inc. and Culvers, Robert E. Lee & Associates, Inc. is formally requesting a site plan application review for the Culver's Regional Office Building located on parcel 230154500 in the Village of Combined Locks, Wisconsin. The scope of development is to build a 4,140 SF Office Building, paved parking lot, and installation of water, sanitary, and storm utilities. Please see the attached civil design documents, elevations, floor plans, and landscape plan for reference.

Please do not hesitate to contact me regarding any questions.

Sincerely,

ROBERT E. LEE & ASSOCIATES, INC.

Kyle D. Clark

GIS/CAD Technician

Japle linds

KDC

ENC.


PROPOSED PROJECT FOR:

GROWING & MAKING DREAMS

COMBINED LOCKS, WI

PROJECT LOCATION MAP

ENLARGED MAP

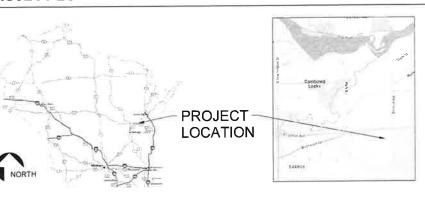



BAYLAND BUILDINGS

P.O. BOX 13571 GREEN BAY, WI 54307 (920) 498-9300 FAX (920) 498-3033


AMS

DRE/

DESIGN & BUILD GENERAL CONTRACTOR

PROJECT PERSPECTIVE (NTS)
-FOR CONCEPTUAL PROPOSES ONLY!
REFERENCE FLOOR PLANS, ELEVATIONS, SECTIONS, ETC. FOR MORE INFORMATION

SYMBOLS LEGEND

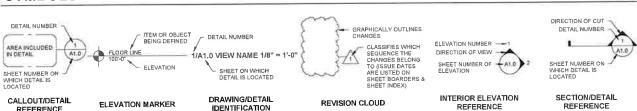

SHEET INDEX

	I	LATEST SHEET REVISIO			
NUMBER	SHEET NAME / DESCRIPTION	DATE	ISSUED BY	NUMBER	
not TITLE					
001 TITLE	TITLE SHEET				
71.1,0	(1).55.35 (65.7				
002 CIVIL					
.C	LOCATION MAPS AND INDEX TO DRAWINGS				
(t)	GENERAL NOTES				
2	EXISTING SITE CONDITIONS				
3	SITE PLAN				
4	UTILITY PLAN				
5	GRADING AND EROSION CONTROL PLAN				
6	MISCELLANEOUS DETAILS				
7	MISCELLANEOUS DETAILS				
8	MISCELLANEOUS DETAILS				
9	EROSION CONTROL INLET PROTECTION TYPES A ,B, C AND D				
10	EROSION CONTROL INLET PROTECTION TYPE D-HR AND TYPE D-M				
11	EROSION CONTROL DITCH CHECK DÉTAILS				
12	EROSION CONTROL SHEET FLOW DETAILS				
13	EROSION CONTROL TRACKOUT CONTROL PRACTICES				
14	EROSION CONTROL EROSION MAT SLOPE APPLICATION DETAILS				
15	EROSION CONTROL EROSION MAT CHANNEL APPLICATION				
	DETAILS				
LS1.0	LIFE SAFETY PLAN				
004 ARCHITEC		_			
A0.1	PLAN NOTES:				
AD.2	PLAN NOTES	_			
A1.0	FLOOR PLAN - OVERALL	_	_		
A1,1	FLOOR PLAN - DIMENSION				
A2.0	ELEVATION - EXTERIOR				
A2,1	ELEVATION - EXTERIOR				
0,£A	SECTIONS - BUILDING				
A3.1	SECTIONS - BUILDING				
A4.0	SECTIONS - WALL / DETAILS			_	
A6.0	SCHEDULES - DOOR / WINDOW		_	_	
A6.1	ROOM FINISH PLAN - OVERALL			_	
A4.2	REFLECTED CEILING PLAN - OVERALL				
A7.0	ROOF PLAN - OVERALL				
	DAI.				
DD5 STRUCTU					
\$0,1	STRUCTURAL DESIGN CRITERIA				
51.0	FOUNDATION PLAN - OVERALL		_		
52.0	FOUNDATION SCHEDULES & DETAILS				
\$2,1	FOUNDATION DETAILS				
53.0	FRAMING PLAN - ROOF				
\$4.0	STRUCTURAL SCHEDULES & DETAILS				

PROJECT INFORMATION

OWNER INFORMATION:
GROWING & MAKING DREAMS INC,
N250 EASTOWNE LN
APPLETON, WI
CONTACT, MAGGIE KAUER
TENANT- CULVERS OFFICE
DIS NO. 920-205-7769 ARCHITECTURAL DATA:
BUILDING CODES
IBC 2015
SCOPE OF WORK NEW BUILDING
BUILDING USE OFFICE & STORAGE

FIRE PROTECTION SYSTEM:
BUILDING IS NOT PROTECTED BY AN AUTOMATIC FIRE SPRINKLER

FIRE & SMOKE PROTECTION FEATURES: ALLOWABLE AREA DETERMINED BY IBC 508.3 NONSEPARATED OCCUPANCIES BUILDING IS SURROUNDED AND ADJOINED BY PUBLIC WAY OR YARDS NOT LESS THAN 60 FT IN WIDTH

BUILDING AREA:

TOTAL BUILDING AREA 3,802 SQ. FT. OCCUPANT LOAD TABULATED

OCCUPANT LOAD TABULATED
FIRST FLOOR (PROPOSED)
OCCUPANCY BUSINESS
ACCESSORY KITCHEN
ACCESSORY: ASSEMBLY
ACCESSORY: ASSEMBLY
ACCESSORY: STORAGE
OCCUPANCY STORAGE (1)
ACCESSORY, GARAGE

TOTAL OCCUPANT LOAD OCCUPANT LOAD (ACTUAL) VERIFY W/ OWNER

PLUMBING FIXTURE REQUIRED

PLUMBING BYTURE REQUIRED
OCCUPANCY
23 / 2 = 12 MEN AND 12 WOMEN
23 / 2 = 12 MEN AND 12 WOMEN
12 / 1 PER 25 FIRST 30 THEN 1 PER 50 = 0.48 WATER CLOSETS FOR MEN
12 / 1 PER 25 FIRST 30 THEN 1 PER 50 = 0.48 WATER CLOSETS FOR WOMEN
12 / 1 PER 25 FIRST 30 THEN 1 PER 80 = 0.3 LAVATORIES FOR MEN
12 / 1 PER 40 FIRST 30 THEN 1 PER 80 = 0.3 LAVATORIES FOR WOMEN
12 / 1 PER 40 FIRST 30 THEN 1 PER 80 = 0.3 LAVATORIES FOR WOMEN
23 / 100 = 0.23 DRINKING FOUNTAINS

OCCUPANCY S-1 6/2 = 3 MEN AND 3 WOMEN 3/1 PER 100 = 0,03 WATER CLOSETS FOR MEN 3/1 PER 100 = 0,03 WATER CLOSETS FOR WOMEN 3/1 PER 100 = 0,03 LAVATORIES FOR MEN 3/1 PER 100 = 0,03 LAVATORIES FOR WOMEN 6/1,000 = 0,01 LAVATORIES FOR WOMEN

PLUMBING FIXTURE PROVIDED
(1) WATER CLOSETS FOR WOME
(1) LAVATORIES FOR WOMEN
(1) WATER CLOSETS FOR MEN
(1) LAVATORIES FOR MEN

PROJECT LUCATION:
MARTINEAU RD & DEBRUIN RD
COMBINED LOCKS, WI
MUNICIPALITY
OUTAGAMIE COUNTY

CONSTRUCTION TYPE

PROPOSED PROJECT FOR

GROWIN MAKING COMBINED LC SCALE VERIFICATION

JOB NUMBER: 25-6060 PROJECT TOM AMBROSIUS (920) 371-2544 DRAWN BY: JRG / AGS 6/5/2025 DATE:

Revision Schedule

Revision Description


ISS	UED FOR:	CHECKED BY:	DATE:			
	PRELIMINARY					
	BID SET					
	DESIGN REVIEW	SM/TA/AS	5/14/25			
	CHECKSET					
x	CONSTRUCTION					
TITLE SHEET						

T1.0

CULVER'S OFFICE SITE DEVELOPMENT FOR BAYLAND BUILDINGS, INC. VILLAGE OF COMBINED LOCKS, OUTAGAMIE COUNTY, WISCONSIN

ATTENTION!

DOWNLOADED PLANS ARE NOT SCALEABLE, NEITHER THE OWNER OR THE ENGINEER SHALL BE HELD RESPONSIBLE FOR THE SCALE OR PRINT QUALITY OF DOWNLOADED PLANS. ONLY PRINTED PLANS FROM BLUE PRINT SERVICE CO., INC. SHALL BE CONSIDERED TO BE SCALEABLE PLANS.

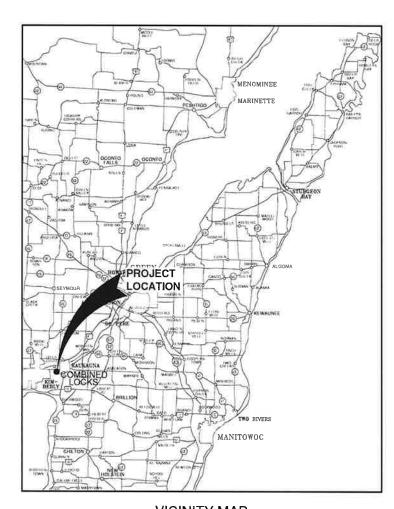

VICINITY MAP

TIE: ISTING UTILITIES SHOWN ON PLANS ARE APPROXIMATE, THE CONTRACTOR SHALL BE SPONSIBLE FOR DETAINING EXACT LOCATIONS AND ELEVATIONS OF ALL UTILITIES, LETHER SHOWN OR NOT, FROM THE COWNERS OF THE RESPECTIVE UTILITIES, ALL UTILITY WIERS SHALL BE NOTIFIED FOR LOCATES BY THE CONTRACTOR 72 HOURS PRIOR TO COMATION.


NOTE:
ALL EROSION CONTROL MEASURES SHA
BE IN PLACE PRIOR TO CONSTRUCTION
AND SHALL CONFORM TO THE WISCONS
DEPARTMENT OF NATURAL RESOURCES
CONSTRUCTION SITE EROSION CONTRO
AND TECHNICAL STANDARDS

INDEX TO DRAWINGS

1	GENERAL NOTES
2	EXISTING SITE CONDITIONS
3	SITE PLAN
4	UTILITY PLAN
5	GRADING AND EROSION CONTROL PLAN
6	MISCELLANEOUS DETAILS
7	MISCELLANEOUS DETAILS
8	MISCELLANEOUS DETAILS
9	EROSION CONTROL - INLET PROTECTION TYPES A, B, C AND D
10	EROSION CONTROL - INLET PROTECTION TYPE D-HR AND TYPE D-M
11	EROSION CONTROL - DITCH CHECK DETAILS
12	EROSION CONTROL - SHEET FLOW DETAILS
13	EROSION CONTROL - TRACKOUT CONTROL PRACTICES
14	EROSION CONTROL - EROSION MAT SLOPE APPLICATION DETAILS
15	EROSION CONTROL - EROSION MAT CHANNEL APPLICATION DETAILS

DESCRIPTION LOCATION MAPS AND INDEX TO DRAWINGS

SHT. NO.

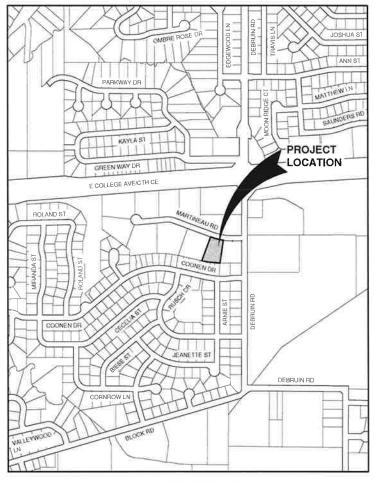

LOCATION MAP

NO.	DATE	APPROV.	REVISION	NO.	DATE	APPROV.	REVISION	DRAWN
. 1	-	_	4					CHECKED
								6
								DESIGNED

CULVER'S OFFICE SITE DEVELOPMENT FOR BAYLAND BUILDINGS, INC. VILLAGE OF COMBINED LOCKS OUTAGAMIE COUNTY, WISCONSIN

LOCATION MAPS AND INDEX TO DRAWINGS





LAND OF DREAMS IV N250 EASTWONE LANE APPLETON, WI 54915

(920) 427-9897

CONTACT: MAGGIE KAUER

CONTRACTOR INFORMATION:

BAYLAND BUILDINGS, INC. P.O. BOX 13571 GREEN BAY, WI 54307

(920) 680-8110

CONTACT: DAVID O'BRIEN

UTILITY INFORMATION:

UTILITIES PRESENT:

VILLAGE OF COMBINED LOCKS DEPARTMENT OF PUBLIC WORKS, KAUKAUNA UTILITIES, WE ENERGIES, AT&T, TIME WARNER,

UTILITIES SHOWN ON THIS MAP ARE BASED ON LOCATES FROM:

DIGGER'S HOTLINE TICKETS NUMBERED 20251827838 AND 2025182784, BOTH DATED 05/12/2025 VISIBLE OBSERVATION (05/14/2025) AND RECORD UTILITY PLAN DOCUMENTS. UTILITY LINE LOCATIONS SHOULD BE VERIFIED PRIOR TO ANY DIGGING. THIS SITE MAY CONTAIN BURIED UTILITIES NOT IDENTIFIED ON THIS MAP.

DIGGERS HOTLINE = 1-800-242-8511

WATER/SANITARY/STORM SEWER: DEPARTMENT OF PUBLIC WORKS VILLAGE OF COMBINED LOCKS 405 WALLACE ST. COMBINED LOCKS, WI 54113

(920) 788-7740

TELECOMMUNICATIONS:

ST. LOUIS MO 63131

TELECOMMUNICATIONS: SPECTRUM / TIME WARNER / CHARTER 12405 POWERSCOURT DR.

WATER/ELECTRIC:

777 ISLAND ST. KAUKAUNA, WI 54130

(920) 766-5721

KAUKAUNA UTILITIES

NET LEC / NSIGHT / CELLCOM C/O MI TECH SERVICES 221 W, WASHINGTON ST. APPLETON, WI 54911

TELECOMMUNICATIONS: TDS METROCOM / TDS TELECOM W6174 AEROTECH DR. - SUITE A APPLETON, WI 54914

TELECOMMUNICATIONS:

AT & T / SBC 221 W. WASHINGTON ST.

APPLETON, WI 54911

(920) 221-5969

GAS & ELECTRIC: WE ENERGIES

(800) 242-9137

800 S. LYNNDALE DR. APPLETON, WI 54914

(262) 446-9821 (920) 739-7659



TO OBTAIN LOCATION OF PARTICIPANTS UNDERGROUND FACILITIES BEFORE YOU DIG IN WISCONSIN

WIS. STATUTE 182,0175 (1974) REQUIRES MIN. OF 3 WORK DAYS NOTICE BEFORE YOU EXCAVATE.

LEGEND

→ FIRE HYDRANT

Ø CURB STOP

W WATER MANHOLE

∇ REDUCER/INCREASER SANITARY MANHOLE

 AIR RELIEF MANHOLE STORM MANHOLE

STORM INLET (NOT IN CURB AND GUTTER)

STORM INLET (IN CURB AND GUTTER)

STORM INLET MANHOLE (C) TANK COVER

SB POST

 IRON PIPE/ROD △ PK NAIL

D POWER POLE ②→ POWER POLE W/GUY WIRE LIGHT POLE

TRAFFIC SIGNAL POLE © FLECTRIC MANHOLE

ELECTRIC METER ① TELEPHONE MANHOLE

TELEPHONE PEDESTAL ○ CABLE TV MANHOLE

 □ CABLE TV PEDESTAL © GAS VALVE

@ GAS METER MAILBOX 4 SIGN

BOLLARD

DECIDUOUS TREE

CONIFEROUS TREE 0 BUSH

RIP RAP

CULVERT

WETLANDS

...

HANDICAP PARKING TO BE REMOVED



TO BE DEMOLISHED

	SANITARY SEWER (SIZE NOTED)
EDGE OF ASPHALT	FORCEMAIN (SIZE NOTED)
	STORM SEWER (SIZE NOTED)
EDGE OF GRAVEL	WATERMAIN (SIZÉ NOTED)
	GAS LINE
CURB & GUTTER	OVERHEAD TELEPHONE LINE
	UNDERGROUND TELEPHONE LINE
TREE/BRUSH LINE	OVERHEAD ELECTRIC LINE
	UNDERGROUND ELECTRIC LINE
150 CONTOUR LINE	OVERHEAD CABLE TV LINE
	CABLE TV LINE
RETAINING WALL	FIBER OPTIC LINE
	R/W LINE
GUARD RAIL	PROPERTY LINE
	EASEMENT LINE
FENCE	BUILDING SETBACK LINE
	SECTION LINE

aR.	GRAVEL	WM	WATERMAIN	١
BIT.	BITUMINOUS	HYD.	HYDRANT	١
SPH	ASPHALT	WV	WATER VALVE	١
CONC	CONCRETE	SAN	SANITARY SEWER	1
W	SIDEWALK	MH	MANHOLE	- (
BLDG	BUILDING	ST	STORM SEWER	-
ISE	HOUSE	CB	CATCH BASIN	-
PED	PEDESTAL	TELE	TELEPHONE	-
P	POWER POLE	ELEC	ELECTRIC	1
.P	LIGHT POLE	TV	TELEVISION	-
180	DENICH MADE	CTA	STATION	F

VERTICAL POINT OF TANGENCY POINT OF CURVATURE POINT OF INTERSECTION POINT OF TANGENCY RADIUS EXISTING PROPOSED EOR END OF RADIUS BOC BACK OF CURB

VPC VERTICAL POINT OF CURVATURE B-B BACK TO BACK (OF CURB) VERTICAL POINT OF INTERSECTION F-F FACE TO FACE (OF CURB) R/W RIGHT OF WAY T/C TOP OF CURB F/L FLOW LINE C/L CENTERLINE R/L REFERENCE LINE INV INVERT CMP CORRUGATED METAL PIPE RCP REINFORCED CONCRETE PIPE


CULV CULVERT


CHECKED


CULVER'S OFFCIE SITE DEVELOPMENT FOR BAYLAND BUILDINGS, INC. VILLAGE OF COMBINED LOCKS OUTAGAMIE COUNTY, WISCONSIN




GENERAL NOTES

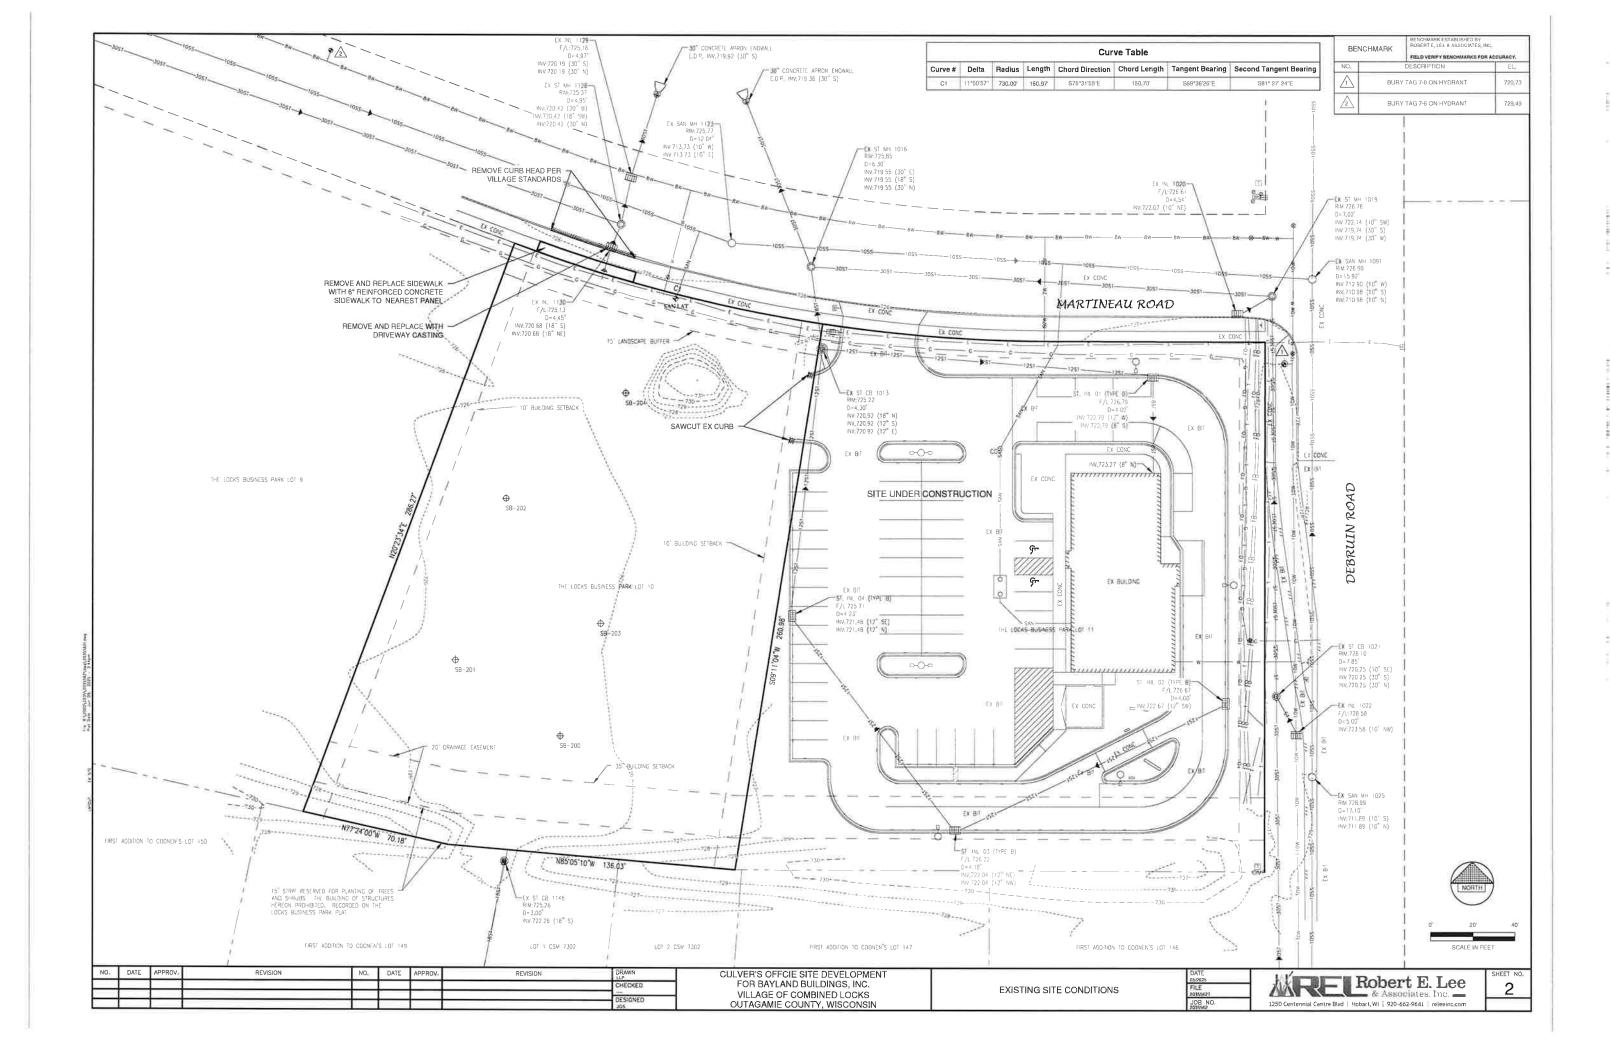


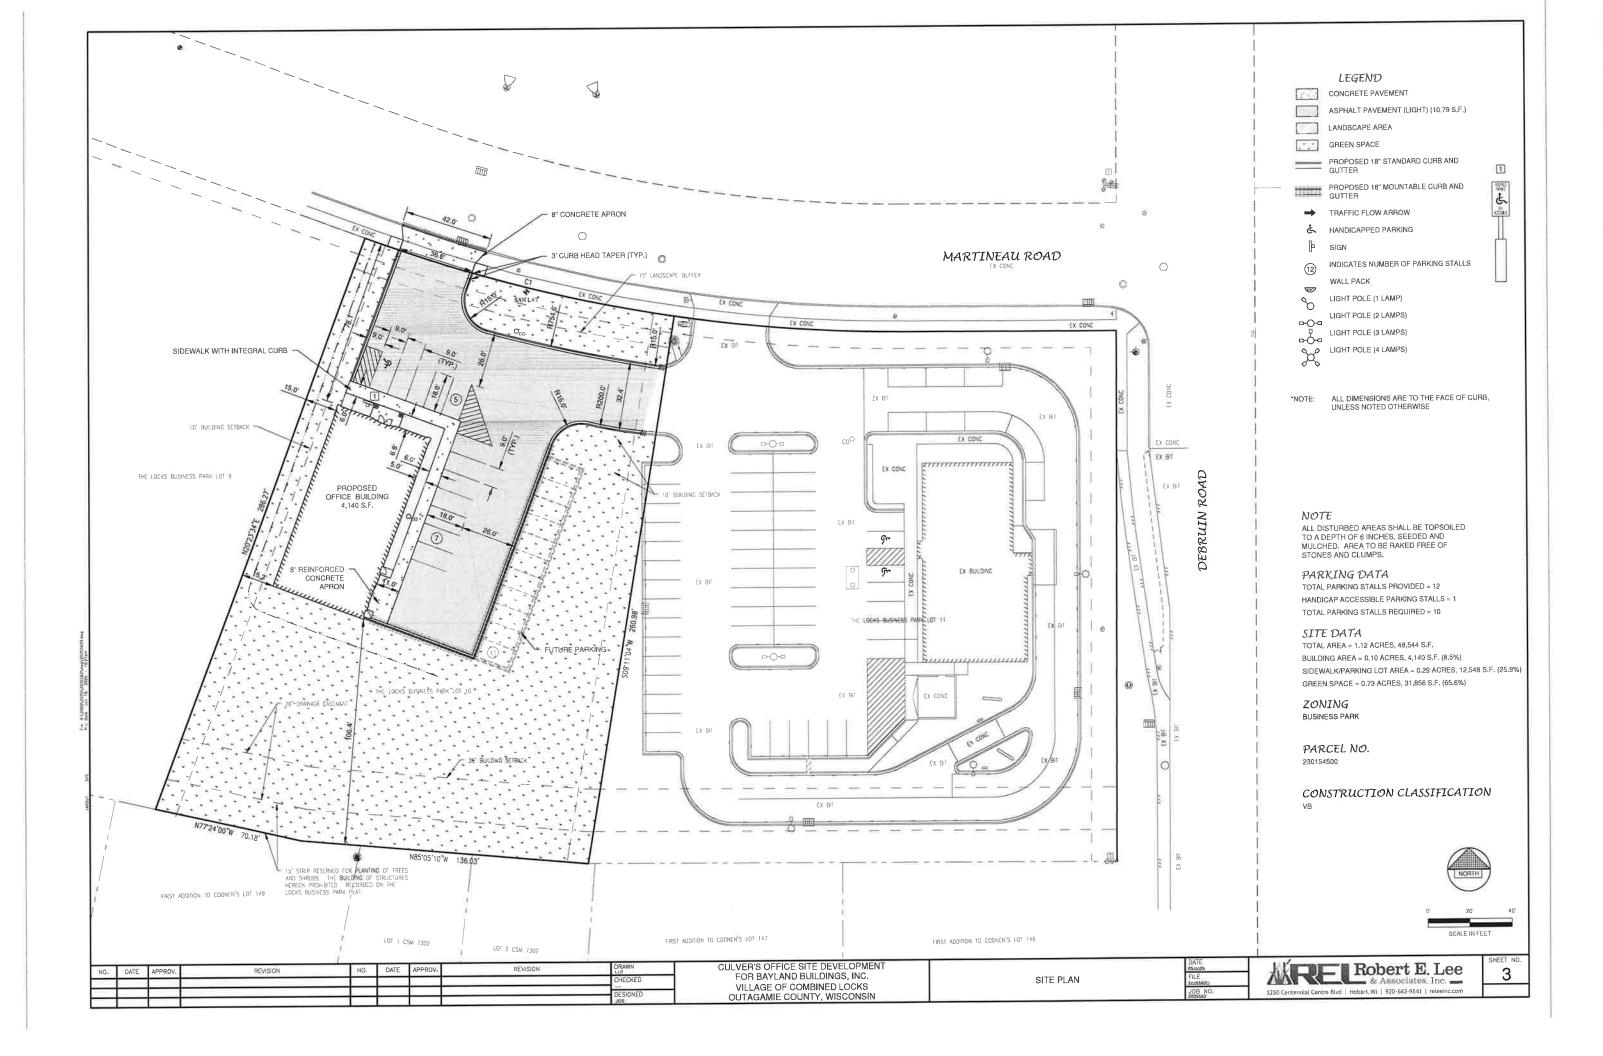

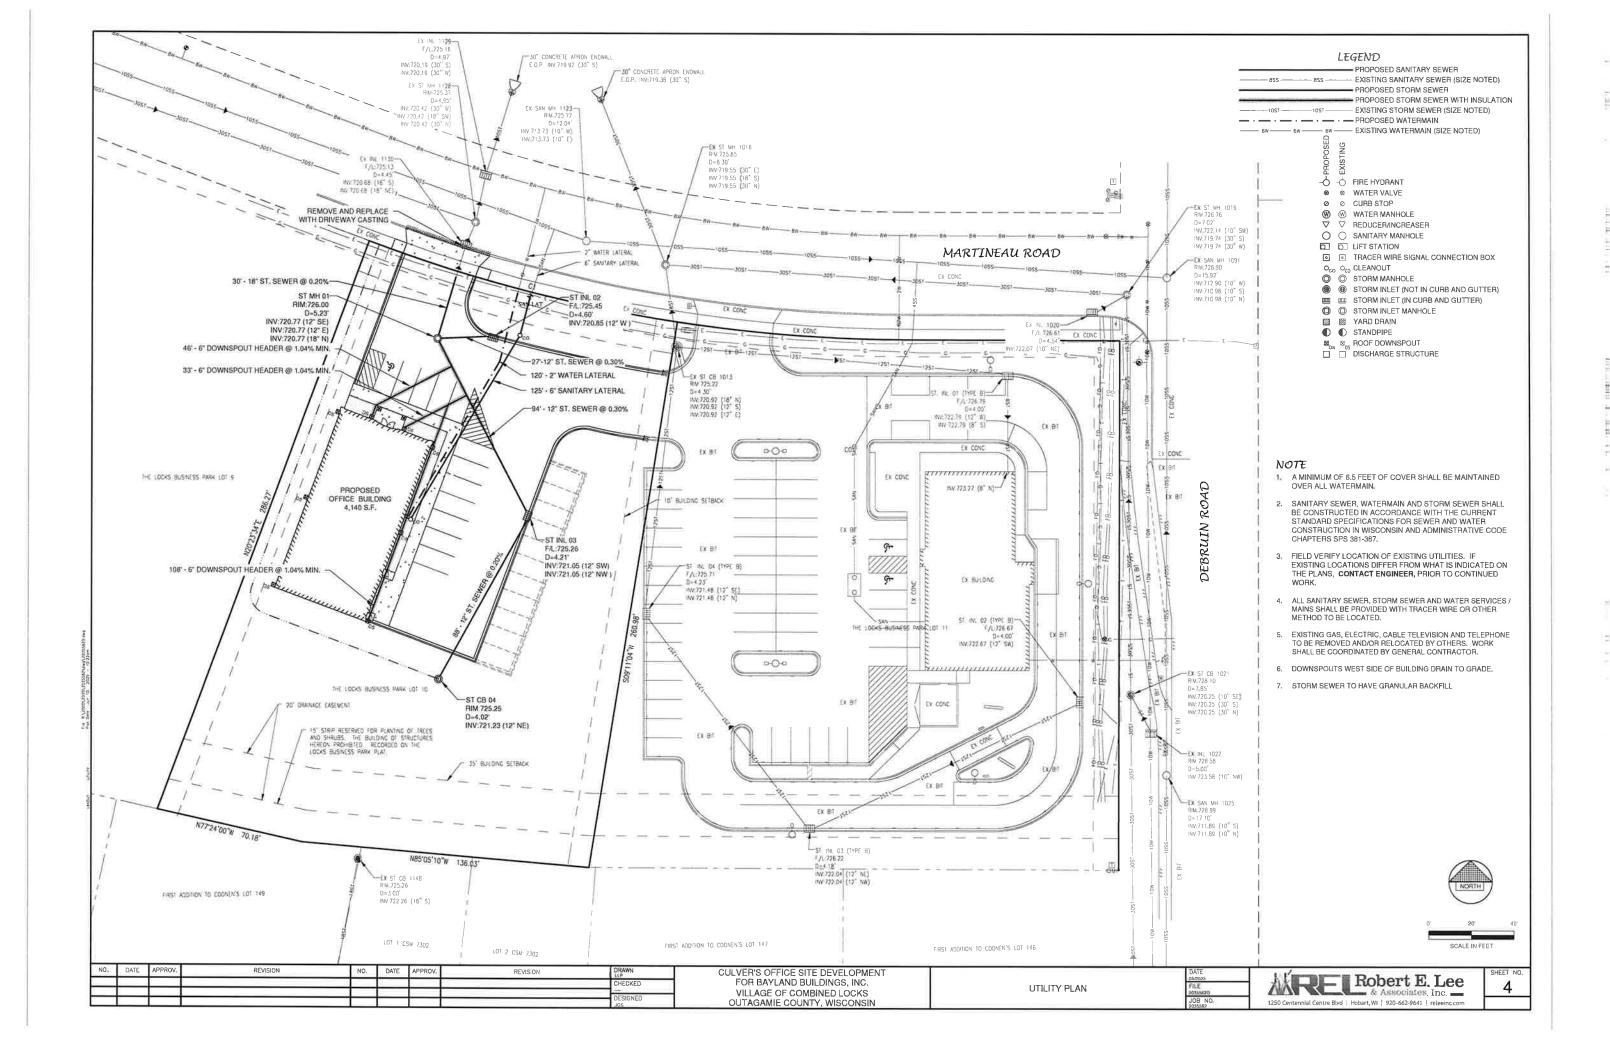

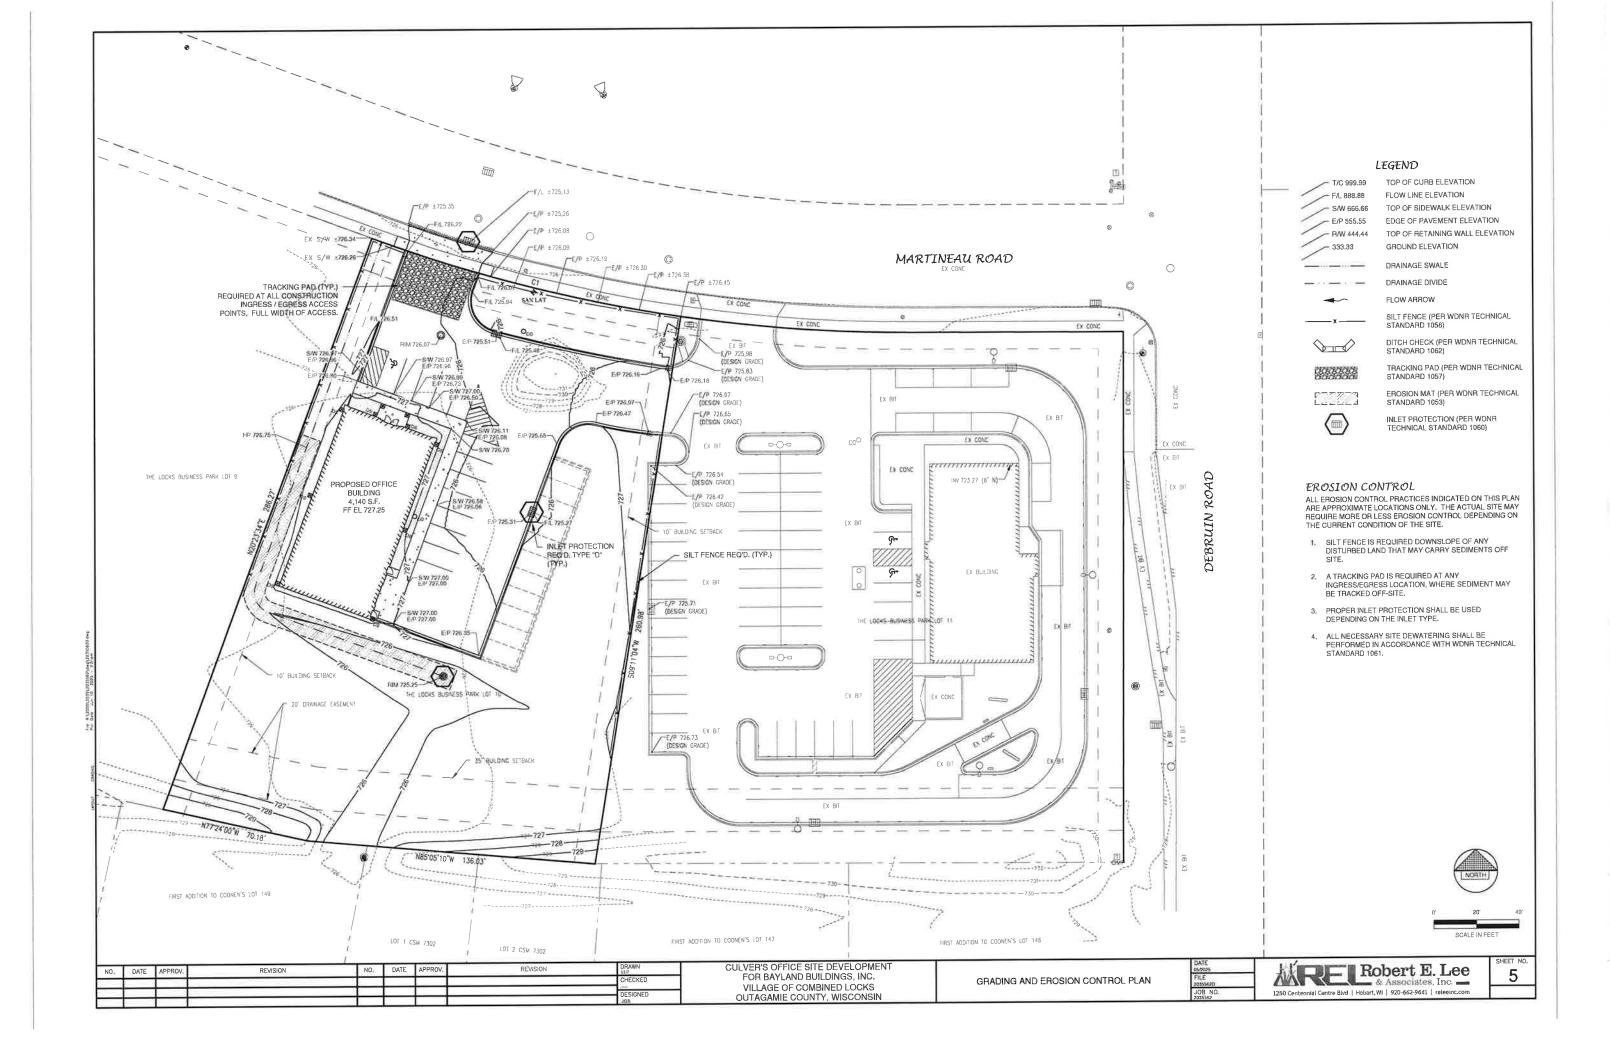

*				

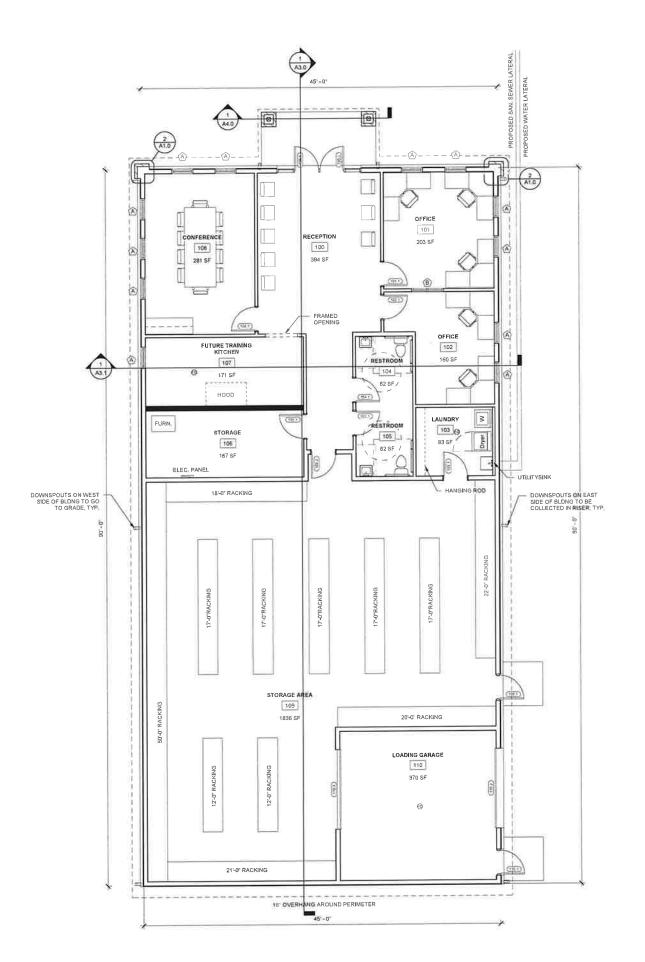



BAYLAND BUILDINGS

P.O. BOX 13571 GREEN BAY, WI 54307 (920) 498-9300 FAX (920) 498-3033 www.baylandbuildings.com

DESIGN & BUILD GENERAL CONTRACTOR

COMBINED LOCKS, WISCONSIN; COUNTY OF: OUTAGAMIE PROPOSED BUILDING FOR: GROWING & MAKING GROWING & DREAMS

SCALE VERIFICATION

JOB NUMBER: 25-6060 PROJECT TOM AMBROSIUS (920) 371-2544 DRAWN BY: JRG / AGS DATE: 6/5/2025

REVISIONS:

ISSUED FOR: CHECKED DATE: PRELIMINARY BID SET DESIGN REVIEW SM/TA/AS 5/14/25 x construction

FLOOR PLAN - OVERALL

A1.0


PLAN NOTES:
1) ALL DIMENSIONS ARE FROM FACE OF STUD TO FACE OF STUD (U.N.O.)


NORTH




2x6 STUD WALL w/ BATT — INSUL (R-21) & 5/8" GYP BD ON INT & 1/2" OSB SHEATHING w/ TYVEK ON EXT_ OF WALL

FLOOR PLAN - BRICK CORNER 2/A1,0 SCALE = 1 1/2" = 1'-0"

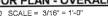

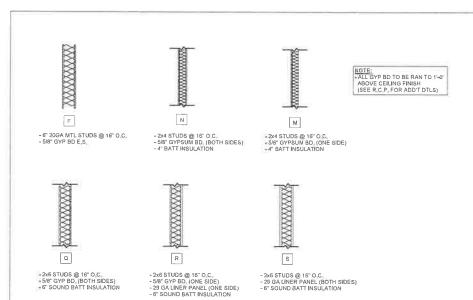

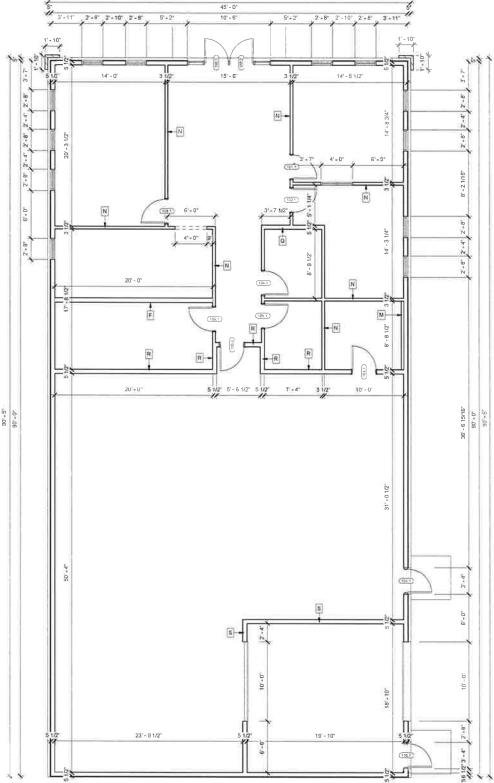



BAYLAND BUILDINGS

P.O. BOX 13571 GREEN BAY, WI 54307 (920) 498-9300 FAX (920) 498-3033 www.baylandbuildings.com

DESIGN & BUILD GENERAL CONTRACTOR

COMBINED LOCKS, WISCONSIN; COUNTY OF: OUTAGAMIE MAKING PROPOSED BUILDING FOR: જ GROWING DREAMS DRE

SCALE VERIFICATION

JOB NUMBER: 25-6060

PROJECT TOM AMBROSIUS (920) 371-2544

DRAWN BY: JRG / AGS

6/5/2025

DATE: REVISIONS:

BID SET

CHECKSET x CONSTRUCTION

PLAN NOTES:

1) ALL DIMENSIONS ARE FROM FACE OF STUD TO FACE OF STUD (U.N.O.)
2) PROVIDE BACKING FOR ANYALL PLUMBING FIXTURES
3) PROVIDE BACKING FOR ALL CASEWORK

FLOOR PLAN - DIMENSION


ISSUED FOR: CHECKED DATE: BY:


DESIGN REVIEW SM/TA/AS 5/14/25





45' - 0"

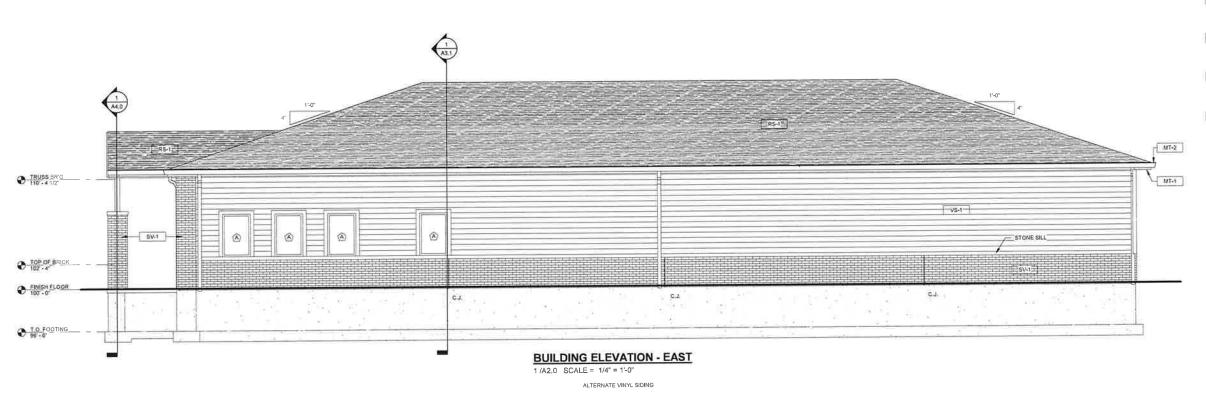

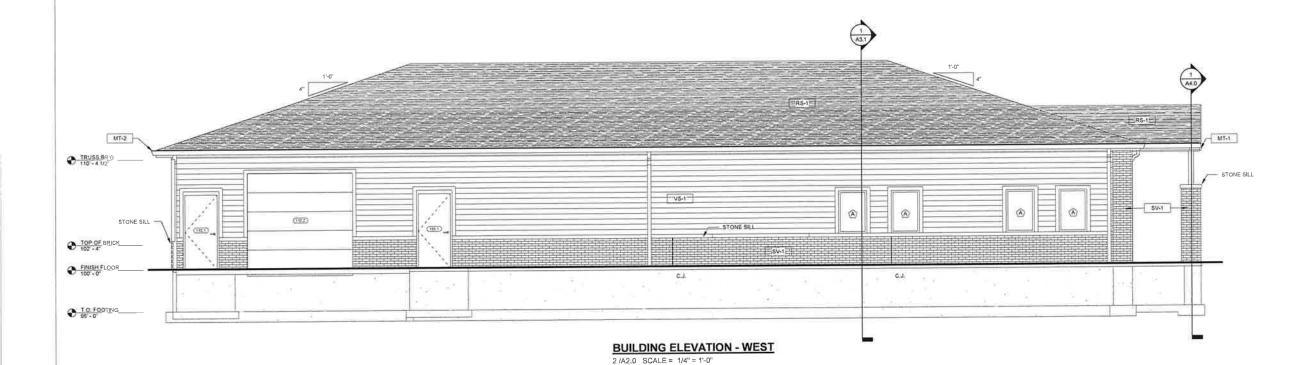

ALTERNATE VINYL SIDING

EXTERIOR FINISH LEGEND

MARK DESCRIPTION

VS-1 LOCATION HORIZ, EXTERIOR SIDING MATERIAL VINYL SIDING SUPPLIER VERIFY COLOR, VERIFY COMMENTS

MT-1 LOCATION FASCIA TRIMS & SOFFITS MATERIAL VERIFY SUPPLIER VERIFY COLOR VERIFY COMMENTS

LOCATION RAKE, GUTTERS & TRIMS
MATERIAL VERIFY
SUPPLIER VERIFY
COLOR VERIFY
COMMENTS

SV-1 LOCATION FACE BRICK MATERIAL 4"FACE BRICK SUPPLIER VERIFY COLOR VERIFY COMMENTS

RS-1 LOCATION ROOF SHINGLES
MATERIAL ASPHALT SHINGLE
SUPPLIER VERIFY
COLOR VERIFY
COMMENTS

BAYLAND BUILDINGS

P.O. BOX 13571 GREEN BAY, WI 54307 (920) 498-9300 FAX (920) 498-3033 www.baylandbuildings.com

DESIGN & BUILD GENERAL CONTRACTOR

COMBINED LOCKS, WISCONSIN; COUNTY OF: OUTAGAMIE PROPOSED BUILDING FOR: GROWING & MAKING GROWING DREAMS

SCALE VERIFICATION

JOB NUMBER: 25-6060 PROJECT TOM AMBROSIUS (920) 371-2544 DRAWN BY: JRG / AGS


6/5/2025

DATE: REVISIONS:


ISSUED FOR: CHECKED DATE: BID SET DESIGN REVIEW SM/TA/AS 5/14/25 CHECKSET x CONSTRUCTION

ELEVATION - EXTERIOR

A2.0

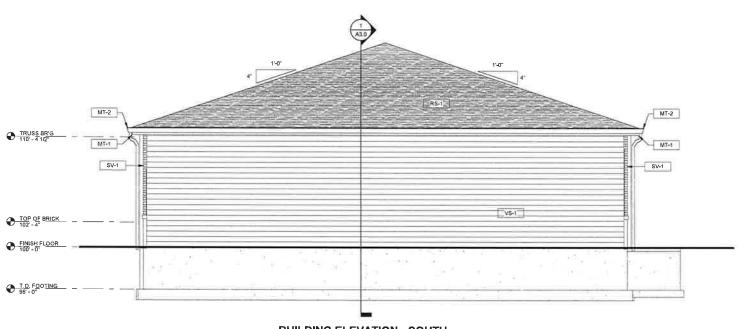

BUILDING ELEVATION - SOUTH
1/A2,1 SCALE = 1/4" = 1'-0" ALTERNATE SIDING VINYL

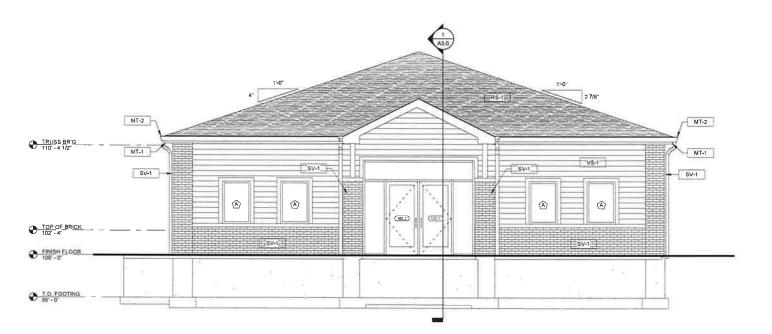

BULLERNATE SIDING VINYL'ATION - NORTH 2 /A2.1 SCALE = 1/4" = 1'-0"

EXTERIOR FINISH LEGEND

MARK DESCRIPTION

VS-1 LOCATION HORIZ EXTERIOR SIDING MATERIAL VINYL SIDING SUPPLIER WERFY COLOR VERIFY COMMENTS

MT-1 LOCATION FASCIA TRIMS & SOFFITS MATERIAL VERIFY SUPPLIER VERIFY COLOR VERIFY COMMENTS

MT-2 LOCATION RAKE, GUTTERS & TRIMS MATERIAL VERIFY SUPPLIER VERIFY COLOR VERIFY COMMENTS

SV-1 LOCATION FACE BRICK MATERIAL 4" FACE BRICK SUPPLIER VERIFY COLOR VERIFY COMMENTS

RS-1 LOCATION ROOF SHINGLES
MATERIAL ASPHALT SHINGLE
SUPPLIER VERIEY
COLOR VERIEY
COMMENTS

BAYLAND BUILDINGS

P.O. BOX 13571 GREEN BAY, WI 54307 (920) 498-9300 FAX (920) 498-3033 www.baylandbuildings.com

DESIGN & BUILD GENERAL CONTRACTOR

COMBINED LOCKS, WISCONSIN; COUNTY OF: OUTAGAMIE MAKING PROPOSED BUILDING FOR: య GROWING DREAMS

SCALE VERIFICATION

JOB NUMBER: 25-6060


PROJECT TOM AMBROSIUS (920) 371-2544


DRAWN BY: JRG / AGS DATE: 6/5/2025

REVISIONS:

ISSUED FOR:	CHECKED BY:	DATE:
PRELIMINARY		
BID SET		
DESIGN REVIEW	W SM/TA/AS	5/14/25
CHECKSET		
x constructio	N	
EL EVATIO	N - EYTERIC	nP

A2.1

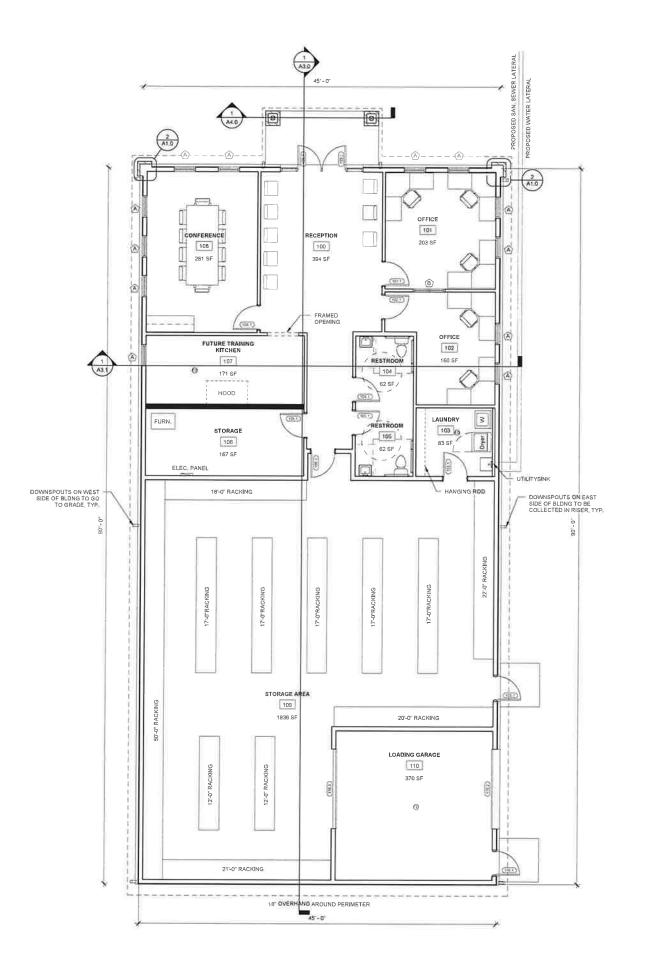

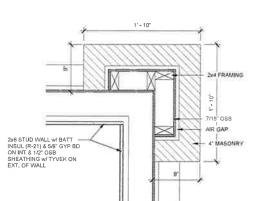

FLOOR PLAN - BRICK CORNER

2 /A1_0 SCALE = 1 1/2" = 1'-0"



BAYLAND BUILDINGS

P.O. BOX 13571 GREEN BAY, WI 54307 (920) 498-9300 FAX (920) 498-3033 www.baylandbuildings.com

DESIGN & BUILD GENERAL CONTRACTOR

COMBINED LOCKS, WISCONSIN; COUNTY OF: OUTAGAMIE PROPOSED BUILDING FOR: GROWING & MAKING DREAMS

SCALE VERIFICATION

JOB NUMBER: 25-6060 PROJECT TOM AMBROSIUS (920) 371-2544

DRAWN BY: JRG / AGS DATE: 6/5/2025

REVISIONS:


PLAN NOTES: 1) ALL DIMENSIONS ARE FROM FACE OF STUD TO FACE OF STUD (U.N.O.)






	BY:	DATE:
PRELIMINARY		
BID SET		
DESIGN REVIEW	V SM/TA/AS	5/14/25
CHECKSET		
x CONSTRUCTION	٧	

A1.0

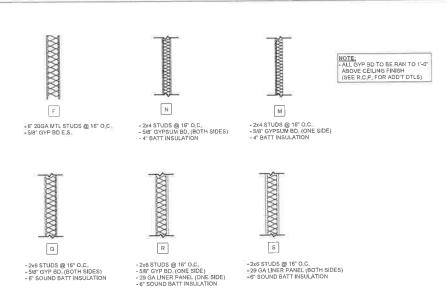

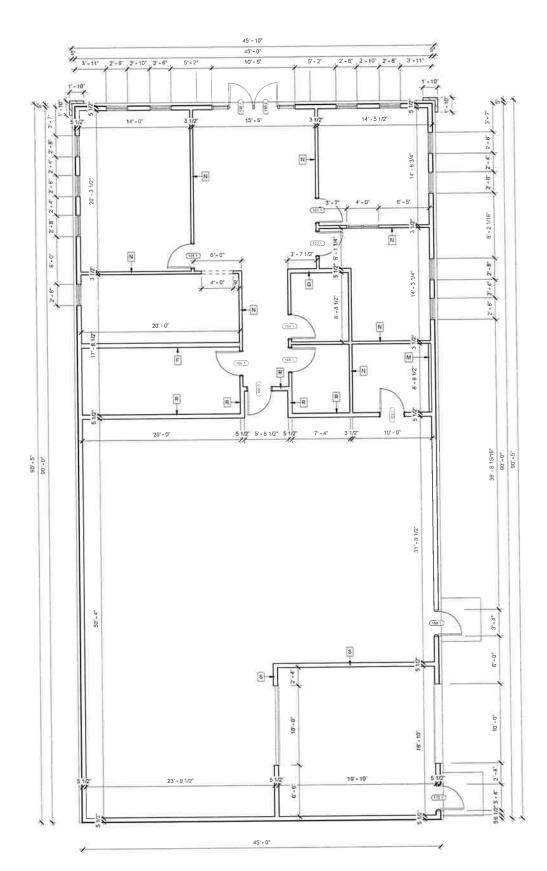



BAYLAND BUILDINGS

P.O. BOX 13571 GREEN BAY, WI 54307 (920) 498-9300 FAX (920) 498-3033 www.baylandbuildings.com

OF

DESIGN & BUILD GENERAL CONTRACTOR

COMBINED LOCKS, WISCONSIN; COUNTY OUTAGAMIE MAKING PROPOSED BUILDING FOR: GROWING & MAK DREAMS

SCALE VERIFICATION

JOB NUMBER: 25-6060

PROJECT TOM AMBROSIUS (920) 371-2544

DRAWN BY: JRG / AGS DATE: 6/5/2025

REVISIONS:

PLAN NOTES:
1) ALL DIMENSIONS ARE FROM FACE OF STUD TO FACE OF STUD (U.N.O.)
2) PROVIDE BACKING FOR ANYMAL PLUMBING FIXTURES
3) PROVIDE BACKING FOR ALL CASEWORK

DESIGN REVIEW SM/TA/AS 5/14/25 CHECKSET

ISSUED FOR: CHECKED DATE: BY:


x construction


BID SET

FLOOR PLAN - DIMENSION





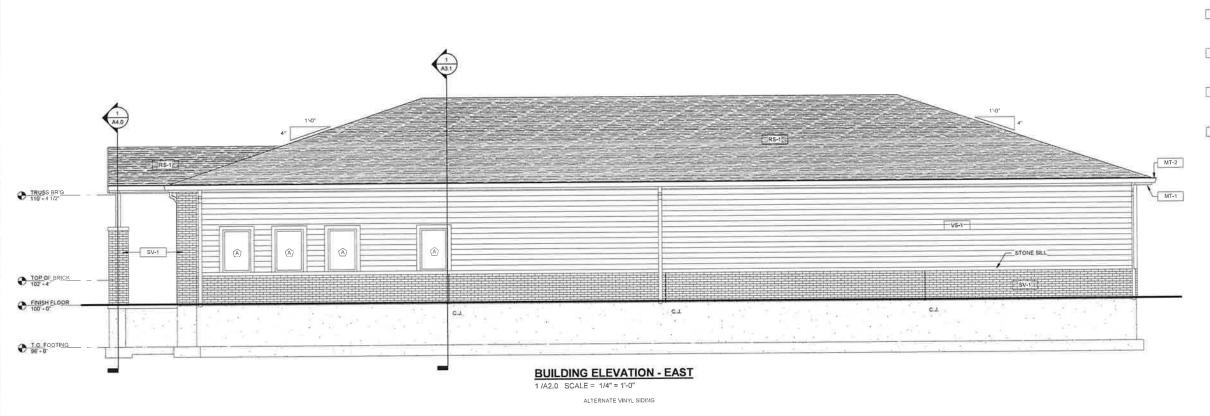

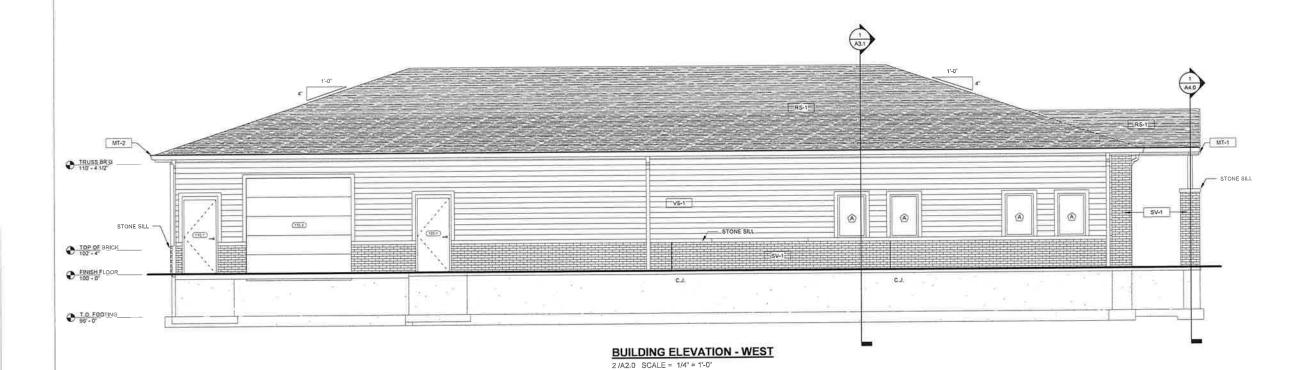

ALTERNATE VINYL SIDING

EXTERIOR FINISH LEGEND

MARK DESCRIPTION

US-1 LOCATION HORIZ, EXTERIOR SIDING MATERIAL VINYL SIDING SUPPLIER VERIFY COLOR VERIFY COMMENTS

MT-1 LOCATION FASCIA TRIMS & SOFFITS
MATERIAL VERIEY
SUPPLIER VERIEY
COLOR VERIEY
COMMENTS

MT-2
LOCATION RAKE GUTTERS & TRIMS
MATERIAL VERIFY
SUPPLIER VERIFY
COLOR VERIFY
COMMENTS

SV-1 LOCATION FACE BRICK MATERIAL 4"FACE BRICK SUPPLIER VERIFY COLOR VERIFY COMMENTS

RS-1 LOCATION ROOF SHINGLES
MATERIAL ASPHALT SHINGLE
SUPPLIER VERIFY
COLOR VERIFY
COMMENTS

BAYLAN

BAYLAND BUILDINGS

P.O. BOX 13571 GREEN BAY, WI 54307 (920) 498-9300 FAX (920) 498-3033 www.baylandbuildings.com

DESIGN & BUILD GENERAL CONTRACTOR

PROPOSED BUILDING FOR:

GROWING & MAKING

DREAMS

COMBINED LOCKS, WISCONSIN; COUNTY OF:
OUTAGAMIE

SCALE VERIFICATION

NOTICE OF COPYRIGHT
THESE PLANS ARE COPYRIGHTED AND ARE SUBJECT TO
DOPPRIGHT PROTECTION AS AN "ARCHITECTURAL WORK" UNDER
SEC. 130 OF THE COPYRIGHT ACT, IT U.S.C. ALL AND HOLD
OF THE COPYRIGHT ACT, IT U.S.C. ALL AND HOLD
OF THE COPYRIGHT PROTECTION ACT OF 140 S. AND HOLD
OF THE COPYRIGHT PROTECTION ACT OF 140 S. AND HOLD
OF THE COPYRIGHT PROTECTION ACT OF 140 S. AND HOLD
OF THE COPYRIGHT PROTECTION ACT OF 140 S. AND HOLD
OF THE COPYRIGHT PROTECTION ACT OF 140 S. AND HOLD
OF THE COPYRIGHT PROTECTION ACT OF 140 S. AND HOLD
OF THE COPYRIGHT PROTECTION ACT OF 140 S. AND HOLD
OF THE COPYRIGHT PROTECTION ACT OF 140 S. AND HOLD
OF THE COPYRIGHT PROTECTION AND HOLD
OF THE COPYR

 JOB NUMBER:
 25-6060

 PROJECT EXECUTIVE:
 TOM AMBROSIUS (920) 371-2544

 DRAWN BY:
 JRG / AGS

6/5/2025

DATE: REVISIONS:

ISSUED FOR: CHECKED BY:

PRELIMINARY

SID SET


DESIGN REVIEW SM/TA/AS 5/14/25

CHECKSET


X CONSTRUCTION

ELEVATION - EXTERIOR

A2.0

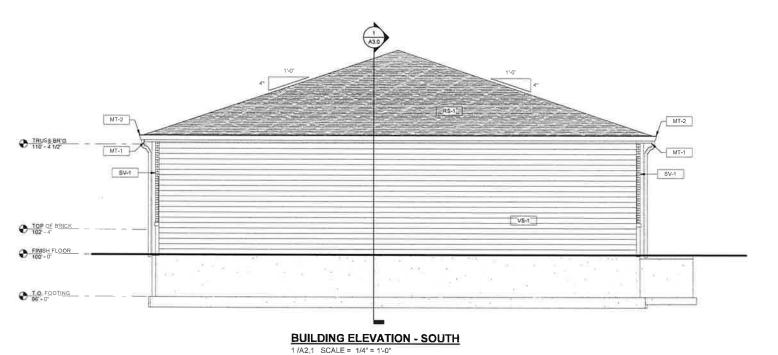

ALTERNATE SIDING VINYL

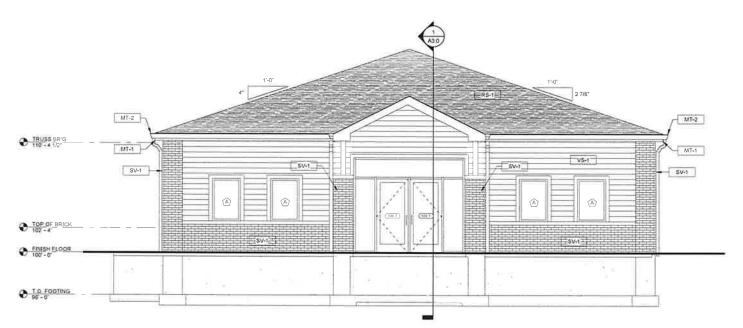

BUILTENATE SIDING VINYL'ATION - NORTH 2 /A2,1 SCALE = 1/4" = 1'-0"

EXTERIOR FINISH LEGEND

MARK DESCRIPTION

US-1 LOCATION HORIZ, EXTERIOR SIDING MATERIAL VINYL SIDING SUPPLIER VERIFY COLOR VERIFY COMMENTS

MT-1 LOCATION FASCIA TRIMS & SOFFITS
MATERIAL VERIFY
SUPPLIER VERIFY
COLOR VERIFY
COMMENTS

MT-2
LOCATION RAKE GUTTERS & TRIMS
MATERIAL VERIFY
SUPPLIER VERIFY
COLOR VERIFY
COMMENTS

SV-1 LOCATION FACE BRICK MATERIAL 4" FACE BRICK SUPPLIER VERIFY COLOR VERIFY COMMENTS

RS-1 LOCATION ROOF SHINGLES
MATERIAL ASPHALT SHOUGLE
SUPPLIER VERIFY
COLOR VERIFY
COMMENTS

BAYLAND BUILDINGS

P.O. BOX 13571 GREEN BAY, WI 54307 (920) 498-9300 FAX (920) 498-3033 www.baylandbuildings.com

DESIGN & BUILD GENERAL CONTRACTOR

COMBINED LOCKS, WISCONSIN; COUNTY OF: OUTAGAMIE PROPOSED BUILDING FOR:
GROWING & MAKING
DREAMS

SCALE VERIFICATION
THE BAR MAGINES 1" ON ORIGINAL.
ADJUST SEAR ACCORDINGLY

JOB NUMBER: 25-6060

PROJECT
EXECUTIVE: TOM AMBROSIUS
(920) 371-2544

DRAWN BY: JRG / AGS DATE: 6/5/2025

REVISIONS:

ISSUED FOR:	CHECKED BY:	DATE:
PRELIMINARY		
BID SET		
DESIGN REVIE	W SM/TA/AS	5/14/25
CHECKSET		
x CONSTRUCTIO	IN	
EL EVATIO	ON EVIENI	20

A2.1



Project Address

Date

Ву

Revision Notes

Culver's Office Development Martineau Road Village of Combined Locks Wisconsin, 54113

elevate outdoor

Design Firm

Elevate Outdoor LLC. 1112 Bryan Road O'Fallon, Missouri 63366

metert

Mark Gawriluk



Title

Culver's Office Development


ret Take

Landscape Plan

Project Manager	Project ID
MVG	Scale 1" = 20'
Reviewed By	Sheel No.
Date	L-1
6/17/2025	of
	1

CULVER'S OFFICE SITE DEVELOPMENT FOR BAYLAND BUILDINGS, INC. VILLAGE OF COMBINED LOCKS, OUTAGAMIE COUNTY, WISCONSIN

DOWNLOADED PLANS ARE NOT SCALEABLE, NEITHER THE OWNER OR THE ENGINEER SHALL BE HELD RESPONSIBLE FOR THE SCALE OR PRINT QUALITY OF DOWNLOADED PLANS. ONLY PRINTED PLANS FROM BLUE PRINT SERVICE CO., INC. SHALL BE CONSIDERED TO BE SCALEABLE PLANS.

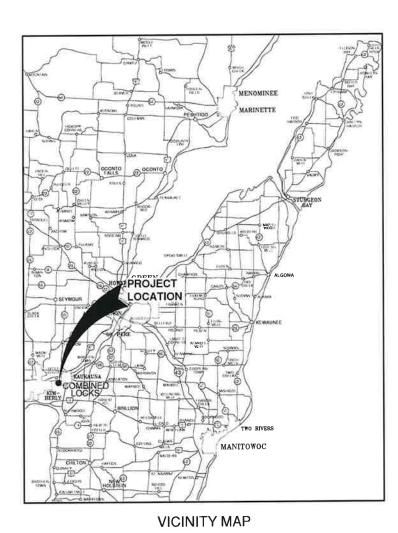

NOTE:

EXISTING UTILITIES SHOWN ON PLANS ARE APPROXIMATE. THE CONTRACTOR SHALL BE
RESPONSIBLE FOR OBTAINING EXACT LOCATIONS AND ELEVATIONS OF ALL UTILITIES,
WHETHER SHOWN OR NOT, FROM THE OWNERS OF THE RESPECTIVE UTILITIES. ALL UTILITY
OWNERS SHALL BE NOTIFIED FOR LOCATES BY THE CONTRACTOR 72 HOURS PRIOR TO
EXCAVATION.

ILLEDOSION CONTROL MEASURES SHA ALL EROSION CONTROL MEASURES SHAI BE IN PLACE PRIOR TO CONSTRUCTION AND SHALL CONFORM TO THE WISCONSI DEPARTMENT OF NATURAL RESOURCES CONSTRUCTION SITE EROSION CONTROL AND TECHNICAL STANDARDS.

INDEX TO DRAWINGS

U.	E	5 C	'n	I۲	П	OIN	

LOCATION MAPS AND INDEX TO DRAWINGS GENERAL NOTES EXISTING SITE CONDITIONS SITE PLAN

UTILITY PLAN GRADING AND EROSION CONTROL PLAN MISCELLANEOUS DETAILS

SHT. NO.

MISCELLANEOUS DETAILS EROSION CONTROL - INLET PROTECTION TYPES A, B, C AND D EROSION CONTROL - INLET PROTECTION TYPE D-HR AND TYPE D-M

EROSION CONTROL - DITCH CHECK DETAILS EROSION CONTROL - SHEET FLOW DETAILS

EROSION CONTROL - TRACKOUT CONTROL PRACTICES EROSION CONTROL - EROSION MAT SLOPE APPLICATION DETAILS EROSION CONTROL - EROSION MAT CHANNEL APPLICATION DETAILS

PROJECT LOCATION

LOCATION MAP

NO.	DATE	APPROV.	REVISION	NO.	DATE	APPROV.	REVISION	DRAWN UP	
,	-							CHECKED	
								DESIGNED	
_								305	L

CULVER'S OFFICE SITE DEVELOPMENT FOR BAYLAND BUILDINGS, INC. VILLAGE OF COMBINED LOCKS OUTAGAMIE COUNTY, WISCONSIN

LOCATION MAPS AND INDEX TO DRAWINGS





Robert E. Lee

(920) 427-9897

CONTACT: MAGGIE KAUER

CONTRACTOR INFORMATION:

BAYLAND BUILDINGS, INC. P.O. BOX 13571 GREEN BAY, WI 54307

(920) 680-8110

CONTACT: DAVID O'BRIEN

UTILITY INFORMATION:

VILLAGE OF COMBINED LOCKS DEPARTMENT OF PUBLIC WORKS, KAUKAUNA UTILITIES, WE ENERGIES, AT&T, TIME WARNER, NET LEC AND TDS METROCOM.

UTILITIES SHOWN ON THIS MAP ARE BASED ON LOCATES FROM:

DIGGER'S HOTLINE TICKETS NUMBERED 20251827838 AND 2025182784, BOTH DATED 05/12/2025 VISIBLE OBSERVATION (05/14/2025) AND RECORD UTILITY PLAN DOCUMENTS. UTILITY LINE LOCATIONS SHOULD BE VERIFIED PRIOR TO ANY DIGGING. THIS SITE MAY CONTAIN BURIED UTILITIES NOT IDENTIFIED ON THIS MAP.

DIGGERS HOTLINE = 1-800-242-8511

WATER/SANITARY/STORM SEWER: DEPARTMENT OF PUBLIC WORKS VILLAGE OF COMBINED LOCKS 405 WALLACE ST. COMBINED LOCKS, WI 54113

(920) 788-7740

WATER/ELECTRIC: KAUKAUNA UTILITIES 777 ISLAND ST. KAUKAUNA, WI 54130

(800) 242-9137

AT & T / SBC 800 S. LYNNDALE DR. APPLETON, WI 54914 221 W. WASHINGTON ST, APPLETON, WI 54911 (920) 221-5969

(920) 766-5721

TELECOMMUNICATIONS: TELECOMMUNICATIONS: SPECTRUM / TIME WARNER / CHARTER NET LEC / NSIGHT / CELLCOM TDS METROCOM / TDS TELECOM 12405 POWERSCOURT DR.

(262) 446-9821

C/O MI TECH SERVICES 221 W. WASHINGTON ST. APPLETON, WI 54911

W6174 AEROTECH DR. - SUITE A APPLETON, WI 54914

GAS & ELECTRIC:

WE ENERGIES

(920) 739-7659

Dial or (800) 242-8511 www.DiggersHotline.com

TO OBTAIN LOCATION OF PARTICIPANTS UNDERGROUND FACILITIES BEFORE YOU DIG IN WISCONSIN

WIS, STATUTE 182,0175 (1974) REQUIRES MIN. OF 3 WORK DAYS NOTICE BEFORE YOU EXCAVATE.

LEGEND

→ FIRE HYDRANT ⊗ WATER VALVE

Ø CURB STOP

W WATER MANHOLE

▼ REDUCER/INCREASER SANITARY MANHOLE

 AIR RELIEF MANHOLE STORM MANHOLE

STORM INLET (NOT IN CURB AND GUTTER)

STORM INLET (IN CURB AND GUTTER) STORM INLET MANHOLE

(I) TANK COVER

⊕_{SB} SOIL BORING ■ POST

IRON PIPE/ROD

△ PK NAIL

POWER POLE D- POWER POLE W/GUY WIRE

占 LIGHT POLE TRAFFIC SIGNAL POLE

© ELECTRIC MANHOLE © ELECTRIC METER

1 TELEPHONE MANHOLE TELEPHONE PEDESTAL CABLE TV MANHOLE

 □ CABLE TV PEDESTAL @ GAS VALVE

GAS METER MAILBOX

4 SIGN BOLLARD

DECIDUOUS TREE

CONIFEROUS TREE \odot

BUSH





HANDICAP PARKING



TO BE REMOVED



TO BE DEMOLISHED

	SANITARY SEWER (SIZE NOTED)
EDGE OF ASPHALT	FORCEMAIN (SIZE NOTED)
	STORM SEWER (SIZE NOTED)
EDGE OF GRAVEL	WATERMAIN (SIZE NOTED)
	GAS LINE
CURB & GUTTER	OVERHEAD TELEPHONE LINE
	UNDERGROUND TELEPHONE LINE
TREE/BRUSH LINE	OVERHEAD ELECTRIC LINE
	UNDERGROUND ELECTRIC LINE
CONTOUR LINE	OVERHEAD CABLE TV LINE
	CABLE TV LINE
PRETAINING WALL	FIBER OPTIC LINE
	- RW LINE
GUARD RAIL	PROPERTY LINE
	EASEMENT LINE
FENCE	BUILDING SETBACK LINE
	SECTION LINE

GR.	GRAVEL	WM	WATERMAIN	VPC	VERTICAL POINT OF CURVATURE
BIT.	BITUMINOUS	HYD.	HYDRANT	VPI	VERTICAL POINT OF INTERSECTION
ASPH	ASPHALT	WV	WATER VALVE	VPT	VERTICAL POINT OF TANGENCY
CONC	CONCRETE	SAN	SANITARY SEWER	PC	POINT OF CURVATURE
SW	SIDEWALK	MH	MANHOLE	Pi	POINT OF INTERSECTION
BLDG	BUILDING	ST	STORM SEWER	PT	POINT OF TANGENCY
HSE	HOUSE	CB	CATCH BASIN	R	RADIUS
PED	PEDESTAL	TELE	TELEPHONE	EX	EXISTING
PP	POWER POLE	ELEC	ELECTRIC	PR	PROPOSED
LP	LIGHT POLE	TV	TELEVISION	EOR	END OF RADIUS
BM	BENCH MARK	STA.	STATION	BOC	BACK OF CURB

	020	511 2.112
	8-B	BACK TO BACK (OF CURB)
N	F-F	FACE TO FACE (OF CURB)
	R/W	RIGHT OF WAY
	T/C	TOP OF CURB
	F/L	FLOW LINE
	C/L	CENTERLINE
	R/L	REFERENCE LINE
	INV	INVERT
	CMP	CORRUGATED METAL PIPE

RCP REINFORCED CONCRETE PIPE


CULV CULVERT


CHECKED


CULVER'S OFFCIE SITE DEVELOPMENT FOR BAYLAND BUILDINGS, INC. VILLAGE OF COMBINED LOCKS OUTAGAMIE COUNTY, WISCONSIN




GENERAL NOTES

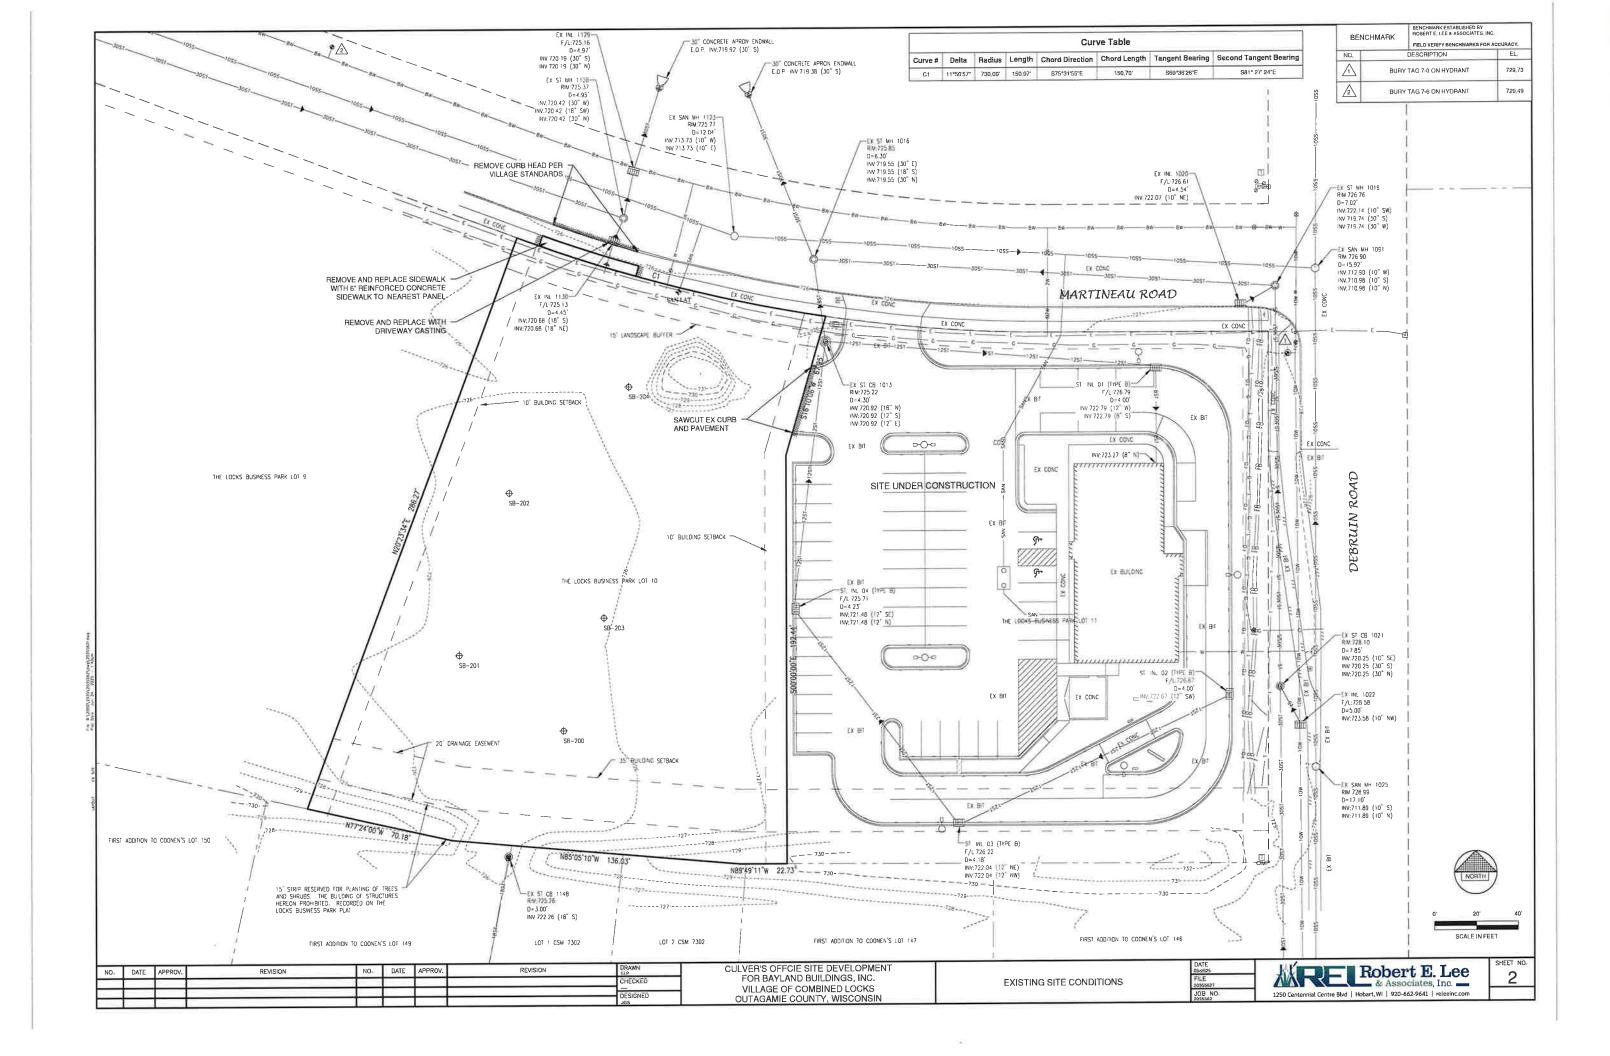

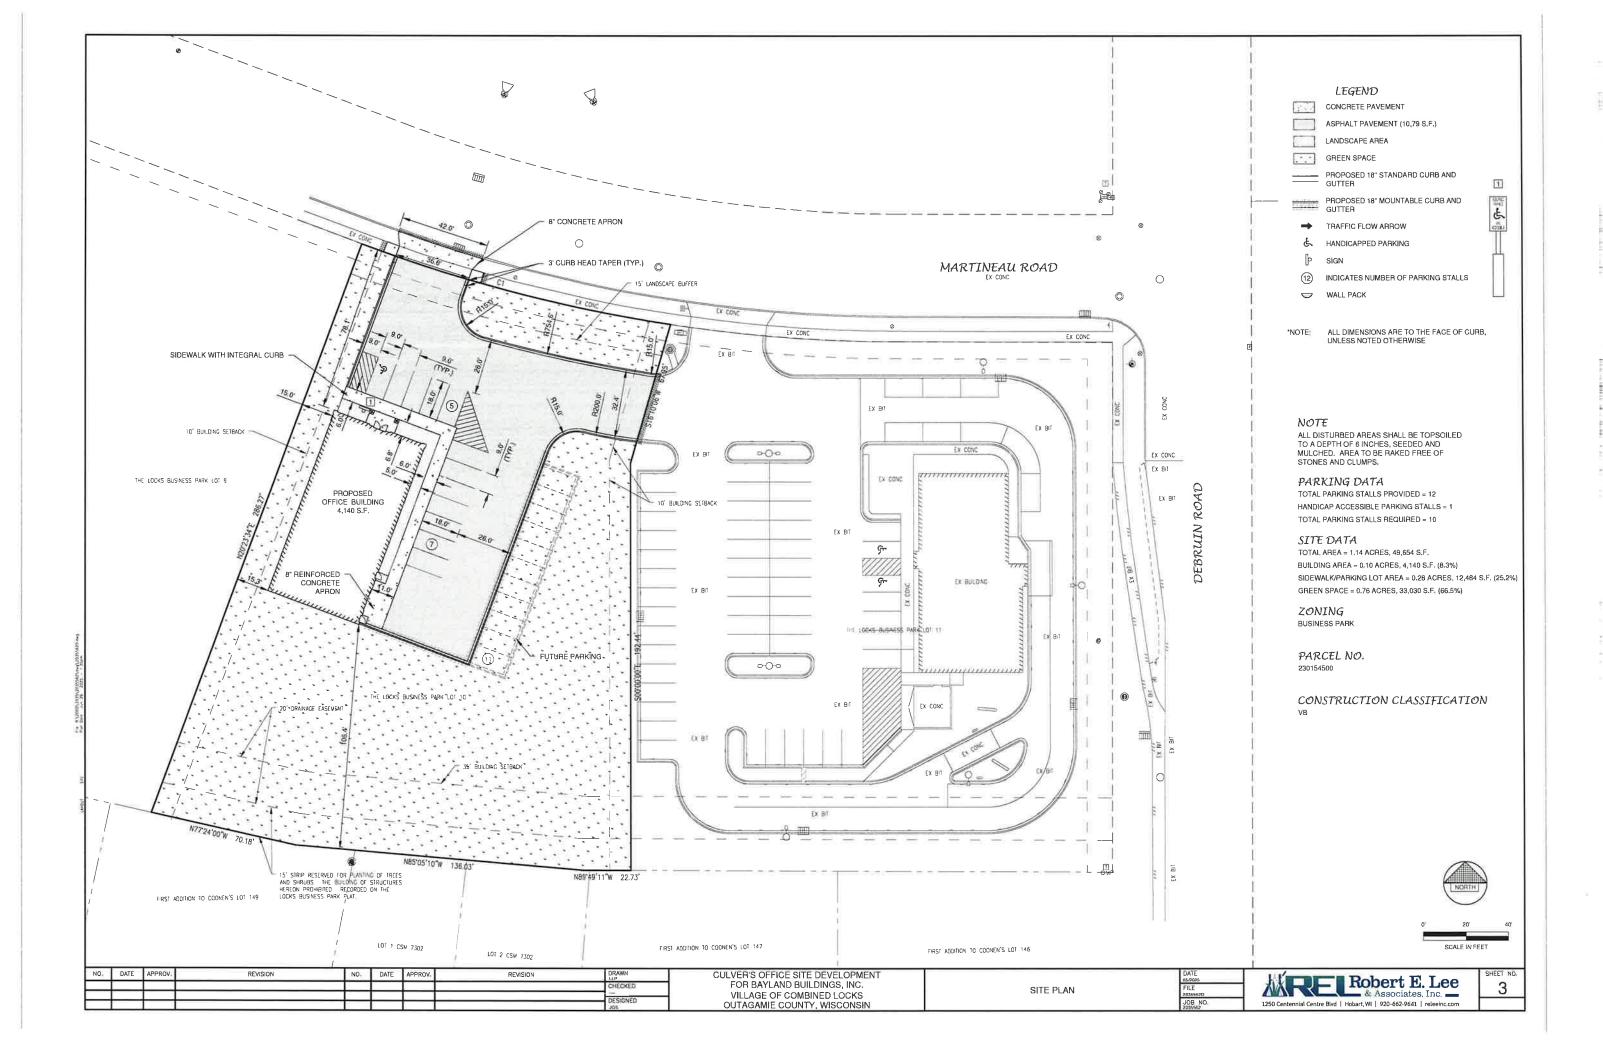

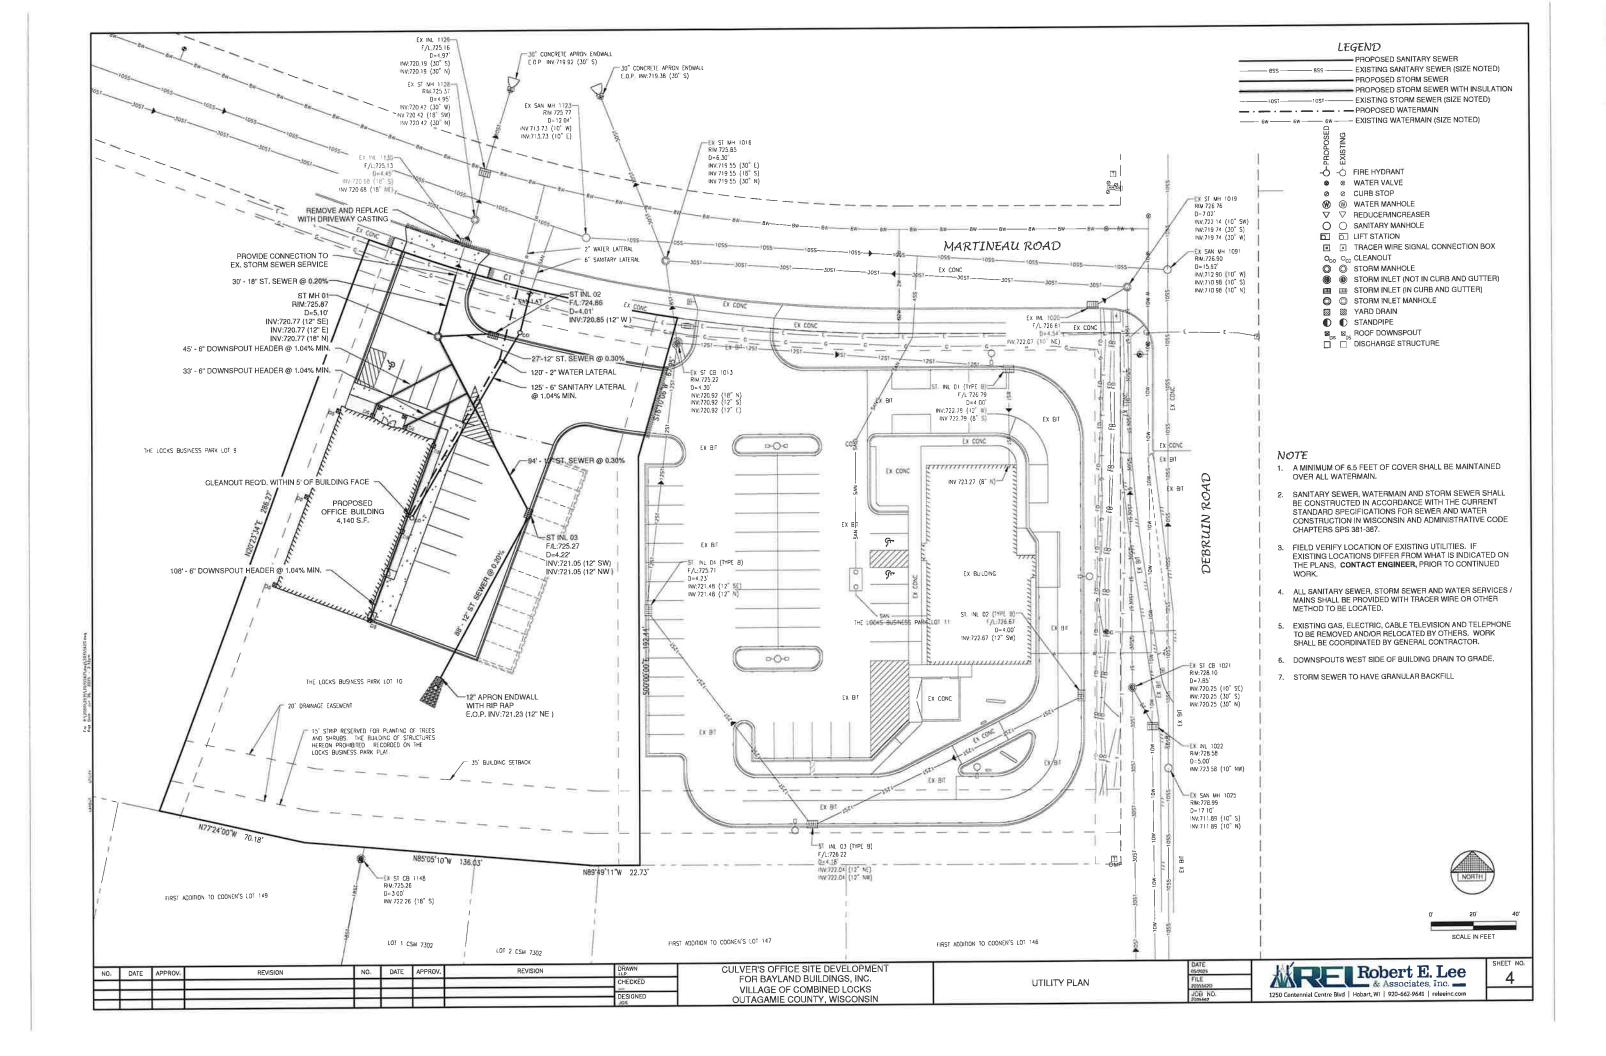

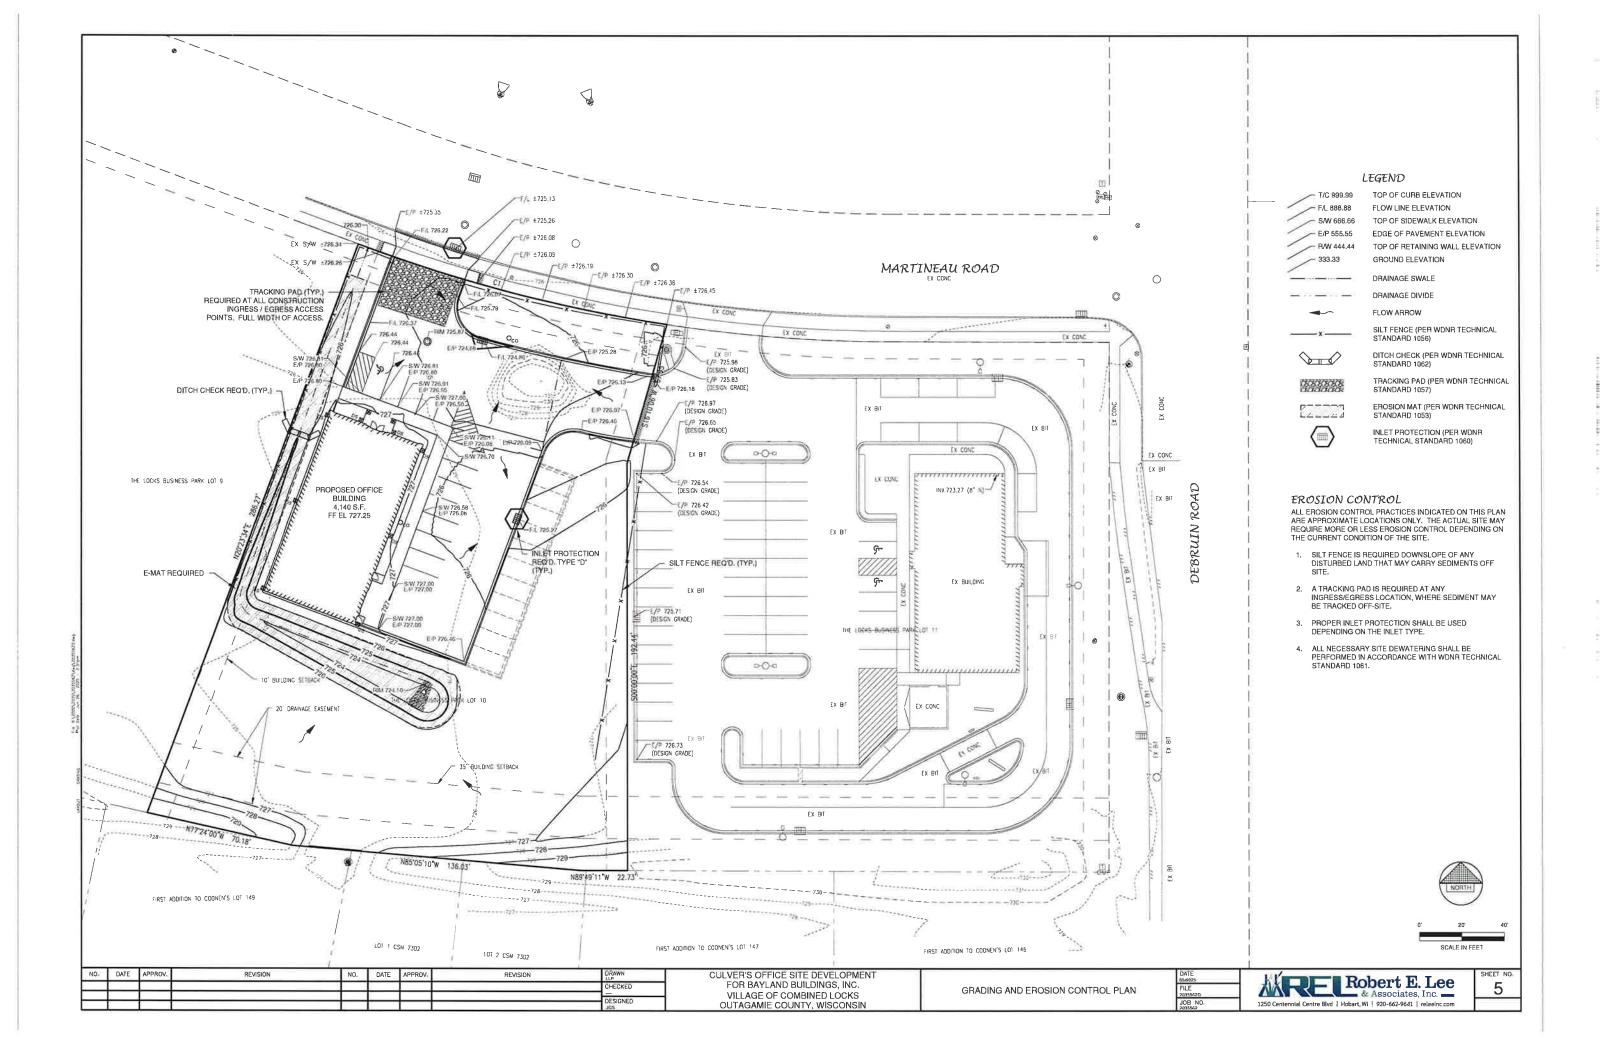

During the public participation exercise for redevelopment of Van Zeeland and Lindberg Parks, a popular addition to Lindberg Park was a mountain bike trail. Plan Commission members are gathering information on this possibility with the help of NEWT (Northeast Wisconsin Trails). The following is information for our research:

REFERENCES:

Here is NEWTs website: newtrailswi.org

We are a chapter of the International Mountain Bicycle Association - IMBA: imba.com

There are likely to be a lot of questions from the unknowing public. The Sheboygan group summarized great responses backed up with highly regarded references:

https://sheboygancountycycling.org/clearing-up-misconceptions-trails-evergreen-park/

Example urban projects:

Green Bay - Baird Creek Skills Park: https://bairdcreek.org/skillspark/

Sheboygan - Evergreen Park: https://sheboygancountycycling.org/our-trails/evergreen-park-trails-campaign/

Janesville - Palmer Urban Mountain Bike Park:

https://www.janesvillecvb.com/recreation/details/4371/273711/Palmer_Urban_Mountain-Bike_Park_PUMP

Example MOU is attached for a NEWT trail at Waukau Dam out near Omro. There are some similarities between sites with the creek, clay soil, etc.

Like I mentioned, the trail construction industry is really developing. The old days of volunteers slowly building good trail on weekends (like all current NEWT trails) are giving way to professionals installing great trails in a fraction of the time. Here are some links to learn more:

Trade association https://www.trailbuilders.org/

Contractors doing recent work in Wisconsin:

https://rocksolidtrails.com/


Dynamic Trailworx https://www.facebook.com/dynamictrailworx

Traction Trailworx: https://www.facebook.com/p/Traction-Trailworx-LLC-100057315255216/

Imba trail solutions https://www.imba.com/programs/trail-solutions

Village of Combined Locks Comprehensive Outdoor Recreation Plan

2025-2030

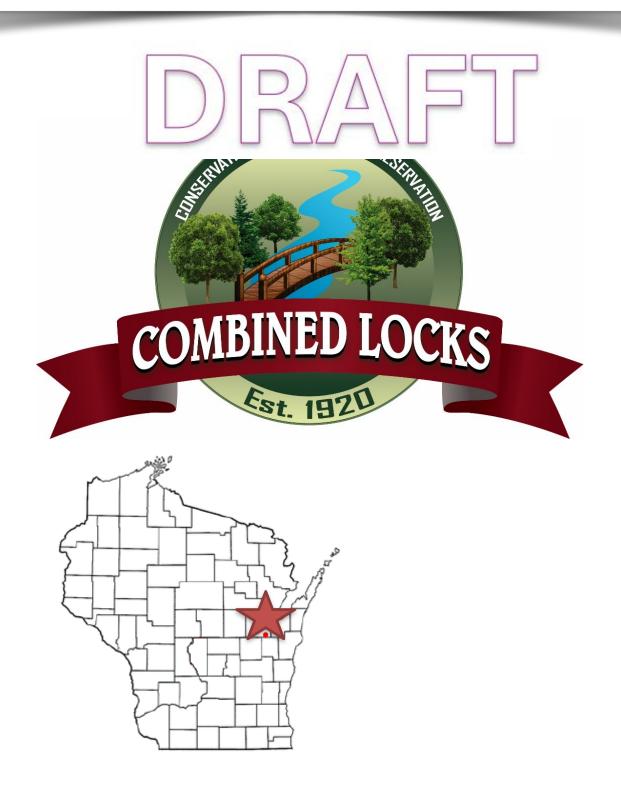

ACKNOWLEDGEMENTS

The preparation of the Village of Combined Locks *Outdoor and Recreation Plan 2025-2030* was formulated by the Plan Commission and Village Staff.

The Combined Locks Village Board adopted it on February XX, 2026

VILLAGE BOARD OF TRUSTEES

John Neumeier, President
Justin Krueger
Al Leicht
Tim Stutzman
Brad Schinke
RJ Talbot

VILLAGE PLAN COMMISSION

Ken Heckner, Chair Kevin Carney John Weyenberg Deane Mader Jeff Maynard Tim Mulry Nate Romberg RJ Talbot

VILLAGE STAFF

Racquel Shampo-Giese, Administrator/Clerk/Treasurer Keith Weyenberg, Co-Director of Public Works Ryan Swick, Co-Director of Public Works Kevin Carney, Parks Manager

Photos

Courtesy of Kimberly High School Digital Media Students (unless otherwise noted)



INTRODUCTION AND PLAN OVERVIEW



Community leaders recognize the importance of strategic planning to protect and enhance the natural resources in our parks, while ensuring a high quality of life for current and future generations.

The 2025-2030 Combined Locks
Comprehensive Outdoor Recreation Plan,
developed by the Plan Commission and
approved by the Village Board of Trustees,
serves as a guide for preserving our unique
natural environment. It enables residents
and visitors to engage in recreational
activities and coexist harmoniously with
nature. The plan also outlines the
development and revitalization of the
community's park system and recreational
facilities.

An inventory of existing parks and facilities has been conducted to establish the plan's goals and objectives. This inventory serves as the foundation for general and site-specific recommendations that will guide all projects in the document. As a dynamic resource, the plan will evolve with the completion of park improvements, updates to recreational amenities, and adjustments to goals and objectives.







ABOUT COMBINED LOCKS



The Village of Combined Locks is located in the southeastern corner of Outagamie County, east of United States Highway 44 and along County Trunk Highway CE. It is bordered by the Fox River and the Village of Little Chute to the north, the Village of Kimberly to the west, the city of Kaukauna to the east, and the town of Buchanan to the south.

The village has a population of approximately 3,641 residents and is part of the larger Fox Cities metropolitan area, which has over 260,000 individuals. Combined Locks has experienced significant growth, with a 37.4% increase in population from 2005 to 2015, and a projected rise of 9.2% from 2015 to 2025.

Originally settled by Dutch, Irish, and German immigrants, the community established the locks system and developed local paper mills. Combined Locks is a riverfront community with a rich Native American history and was incorporated in 1920, initially serving the Combined Locks Paper Company, established in 1889.

The village is known for its high quality of life, featuring well-kept homes, reputable schools, and easy access to shopping and recreational activities.

The paper mill remains a significant employer in the area, and a Business Park is currently under development at the corner of County Trunk Highway CE and Debruin Road. Kwik Trip is the anchor tenant, with Culver's expected to open by summer 2025.

In 2024, a 67-acre site was annexed for residential development, which will include a mix of single-family and multifamily homes, anticipated to be completed within three to five years.





VILLAGE OF COMBINED LOCKS QUICK FACTS





TOTAL **POPULATION**



BACHELORS DEGREE OR BEYOND



1,488 TOTAL HOUSEHOLDS



SQUARE MILE



85% **HIGH SCHOOL** DEGREE OR LESS



2.4 PERSONS PER HOUSEHOLD



MEDIAN AGE



\$89,310 MEDIAN HOUSEHOLD INCOME



HOME **OWNERSHIP**



POPULATION WITH A DISABILITY




1.7% **PERSONS** BELOW **POVERTY LINE**




HOUSEHOLDS WITH NO **VEHICLE**

POPULATION BY AGE RANGE

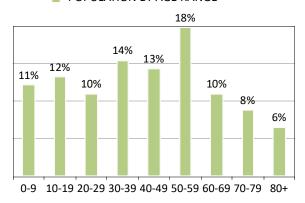

POPULATION BY RACE

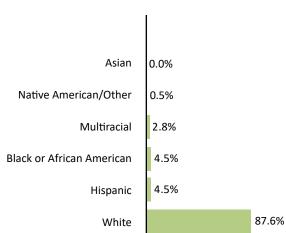

Source American Community Survey (ACS) 2023

COMMUNITY DATA



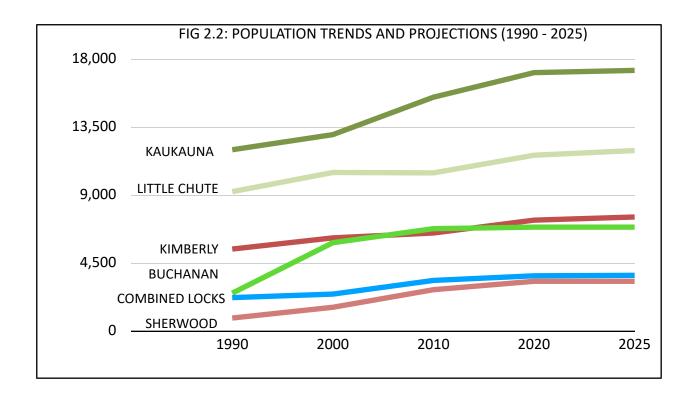


TABLE 2.2: HISTORICAL CENSUS POPULATIONS COMPARISONS, 1990 - 2020


JURISDICTION	1990	2000	2010	2020	2025	% Change 1990 - 2000	% Change 2000 - 2010	% Change 2010 - 2020
V. Combined Locks	2,190	2,422	3,328	3,634	3,665	10.6%	37.4%	9.2%
T. Buchanan	2,484	5,827	6,755	6,857	6,857	134.6%	15.9%	1.5%
C. Kaukauna	11,982	12,983	15,462	17,089	17,237	8.4%	19.1%	10.5%
V. Kimberly	5,406	6,146	6,468	7,320	7,529	13.7%	5.2%	13.2%
V. Little Chute	9,207	10,476	10,449	11,619	11,930	13.8%	-0.3%	11.2%
V. Sherwood	837	1,550	2,713	3,271	3,271	85.2%	75.0%	20.6%

^{*} Data source - Data USA

LAND USE - 2040 VISION STATEMENT



In 2040, the Village of Combined Locks is a thriving community known for its well-kept neighborhoods, excellent parks, extensive trails, and a quality business park. Village leadership focuses on innovative land use and growth management to maintain the high quality of life. Redeveloping obsolete land into higher-value projects has boosted the tax base and reduced the need for new infrastructure investments. Additionally, recreational opportunities are improving with new riverfront spaces, and residential development is carried out sustainably to preserve the Village's unique character

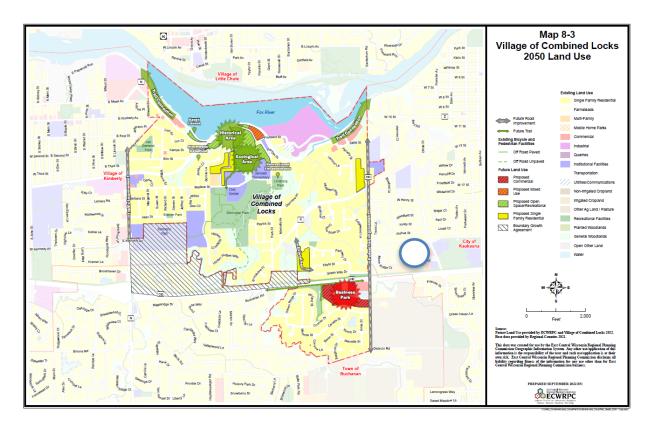

FUTURE PLANS

Recreational development moving forward includes the following:

- The addition of a Historical Area focused on preserving the original Village Hall and Ryan School Building.
- An Ecological Area to recreate natural grasslands, with the potential additional of a dog park and trails..
- Trail connections along Prospect Avenue including the CE trail, Nelson Family Heritage Crossing and the broader Fox Valley network of trails.

HISTORICAL LAND USE - CHANGE OVER TIME




Table 8.3: The Village of Combined Locks Existing 2022 (2025) and Historical 2015 (2020) Land

2022	2022	2022	2015	0/ Change from
Acres	% of Developed vs. Undeveloped Area	% of Total Village Acres	Acres (Historical)	% Change from 2020 to 2025
520.75	56.00%	42.68%	488.47	6.61%
0	0.00%	0.00%	0	0.00%
3.29	0.35%	0.27%	0	0.00%
16.18	1.74%	1.33%	13.9	0.00%
0	0.00%	0.00%	0	0.00%
41.18	4.43%	3.37%	44.47	-7.40%
56.45	6.07%	4.63%	49.02	15.16%
181.04	19.47%	14.84%	176.37	2.65%
33.84	3.64%	2.77%	42.76	-20.86%
77.22	8.30%	6.33%	77.2	0.03%
929.95	76.21%	76.21%	892.19	4.23%
0	0.00%	0.00%	5.28	-100.00%
54.31	18.71%	4.45%	66.83	-18.73%
105.61	36.39%	8.66%	125.36	-15.75%
0	0.00%	0.00%	0	0.00%
0	0.00%	0.00%	0	0.00%
130.31	44.90%	10.68%	129.8	0.39%
290.23	23.79%	23.79%	327.27	-11.32%
1220.18				

Source: East Central Wisconsin Regional Planning Commission, 2015 (2020), 2022 (2025)

RECREATIONAL RESOURCES



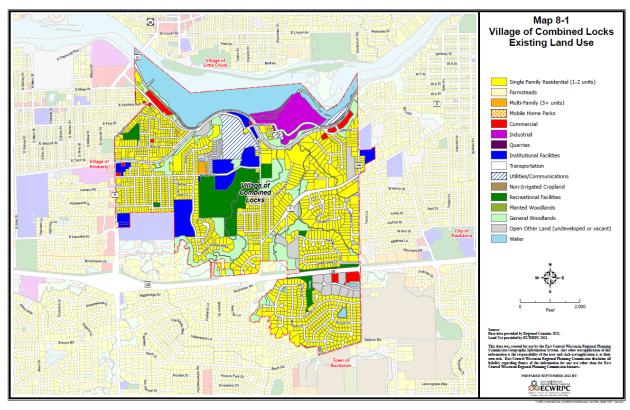

EXISTING PARK FACILITIES

The Village of Combined Locks features eight parks and green spaces, including baseball diamonds and archery ranges. It also boasts natural resources such as Garner's Creek and the wooded areas of Don Fries and Memorial Park, which has a walking trail that connects to the larger regional CE trail. These resources enhance the Village's recreational offerings, foster a thriving community, and provide accessible and diverse outdoor experiences for all residents.

According to the National Recreation and Park Association (NRPA), local communities should provide a minimum of 10 acres of park and open space for every 1,000 residents. Based on this guideline, the Village of Combined Locks currently

requires 31 acres of park space. This figure is projected to increase to XX acres by 2030 as the Village population is expected to grow to XXXX residents.

Currently, the Village of Combined Locks has 93.36 acres of park and recreational land. According to the NRPA standards, the Village has an adequate amount of park and recreational acreage to meet these requirements through the year 2030.

RECREATIONAL RESOURCES



V. Combined Lodd's

7. Buchanan

V. Kankanna

V. Kimheriy

V. Little Chure

V. Shermood

V. Shermood

Figure 8.2. ACRES OF PARKLAND PER 1000 RESIDENTS

TABLE 8.21: ACRES OF PARKLAND PER 1000 RESIDENTS

NRPA Recommended Acres Minimum per 1000 Residents 10 ACRES	Residents	Total Park and Recreational Acreage	Total Park Acreage NRPA (Target)	Acres / 1000 Residents (Actual)				
Jurisdiction								
V. Combined Locks	3,633	93.4	36.3	25.7				
T. Buchanan	6,857	17.5	68.6	2.5				
C. Kaukauna	17,237	458.0	172.4	26.6				
V. Kimberly	7,529	110.0	75.3	14.6				
V. Little Chute	11,930	86.0	119.3	7.2				
V. Sherwood	3,600	52.0	36.0	14.4				

The National Recreation and Park Association (NRPA) recommends that communities should provide a minimum of 10 acres of park and open space for every 1000 residents

RECREATIONAL CLASSIFICATIONS



Table 1.1

Existing Village-Owned Park and Recreational Acreage								
Memorial Park 405 Wallace St.	60.47*	Community Park						
Van Zeeland Park 237 Darboy Rd	5.27	Community Park						
Lindberg Park 415 Park St.	16.28	Community Park						
Blaese Park 535 Richard St.	0.77	Neighborhood Park						
Greenway Park 135 Parkway Dr.	4.42	Neighborhood Park						
Coonen Park 550 Coonen Dr.	6.15	Neighborhood Park						

^{*}Memorial Park acreage excludes the Civic Center site, which occupies 5.51 acres of land

TABLE 2.1. VILLAGE OF COMBINED LOCKS PARK CLASSIFICATION DEFINITIONS

Classification	Definition	Size	Level of Service		
Community Park	Designed to serve a broad segment of the community and provide a wide range of recreational activities. Often host organized sports leagues and are generally located in areas that are easily accessible near major roads and trails	15+ acres	Walking: 0.5 miles Driving: 2 miles		
Neighborhood Park	Basic unit of the park system, intended to serve the immediate neighborhood and a variety of age groups. Often include playgrounds facilities, open play areas, shelters, small sports courts, and toilet facilities	1-15 acres	Walking: 0.25 miles Driving: 0.5 miles		
Mini Park	Serve a very localized area, offering small, accessible recreational spaces for nearby residents. Facilities may include small playgrounds, open play areas, and benches. Amenities are limited due to size, and off-street parking is not necessary.	0.25 - 1 acres	Walking: 0.25 miles Driving: 0.25 miles		
Green Space	Properties designated as parks that have few or no built facilities, but preserve unique land, water, vegatative, historic, and other aesthetic features in their natural state. Often these areas take advantage of streams and other natural features, which help preserve areas for wildlife and other environmental assets of the community. Amenities include walking/hiking trails, environmental corridors, creeks, streams, wetlands, drainage ways, ravines and woodlands, steep sloped areas (12% Or greater) and minimal landscaped areas.	0.25 - 30 acres	Walking: 0.25 miles Driving: 0.25 miles		
Special Facility Park	Designed to cater to specific activities or interests beyond general recreational purposes. Often include specialized equipment or infrastructure such as boat launches, kayak/canoe launches, or historical sites.	1-5 acreas	Walking 0.25 miles Driving: 2 miles		
Greenways and Trails	Lands that effectively tie park system components together to form a continuous park environment, primarily serving bicylists and pedestrians.	Variable	Variable		

OVERALL GOALS AND OBJECTIVES

VISION STATEMENT

Building community by ensuring everyone has access to an ideal system of parks, natural resources, and recreational opportunities that enhance the quality of life for all residents and visitors.

PLAN GOALS

The Comprehensive Outdoor Recreational Plan for the Village of Combined Locks outlines goals and objectives to guide community leaders in developing amenities that enhance the park and recreation system for residents and visitors. These goals represent the ideal conditions for the future—shared aspirations of Village residents that can be achieved through the collective efforts of local officials, private organizations, and individual citizens. The corresponding objectives specify the actions required to attain these goals. Together, the goals and objectives provide a solid foundation for establishing Village policies concerning the future development and management of local parks and recreational areas.



GOALS AND RECOMMENDATIONS



GOAL ONE

To ensure that quality open spaces and recreational facilities are accessible to all residents and visitors of the Village, providing a variety of recreational resources with connectivity where feasible.

OBJECTIVES:

- 1. Offer a comprehensive range of recreational facilities for Combined Locks residents year-round.
- 2. Design active and passive recreational areas to accommodate the elderly and disabled, ensuring they meet the diverse needs of our community.
- Promote regional initiatives to create shared parks for public use, including dog parks, major regional parks, and the conservation of sensitive and significant natural areas.
- 4. Ensure the development of safe and interconnected trail systems throughout the community, linking to neighboring communities.
- 5. Ensure consistent design elements in landscaping, lighting, and signage while incorporating unique amenities in each park.

GOALS AND RECOMMENDATIONS



GOAL TWO

To conserve, protect and improve environmental resources of the Village and surronding areas.

OBJECTIVES:

- 1. Ensure the environmental and aesthetic qualities of the community are considered when planning for future development.
- 2. Protect existing wooded areas, floodplains, and other unique natural features from urban development.
- 3. Preserve and/or create structures and sites that reflect the historical and natural heritage of the area.
- 4. Ensure that future development does not disrupt natural drainage areas in the community.
- 5. Protect our resources from invasive terrestrial plant species with help from volunteers such as the Sierra Club and residents.
- 6. Ensure the preservation of trees for the parks and woodland areas of the Village through proper maintenance, planting of varied species and educating the public on tree care.

GOALS AND RECOMMENDATIONS



GOAL THREE

To encourage continued involvement of Village residents when planning for park and recreational development and redevelopment

OBJECTIVES:

- Conduct public meetings and invite citizen involvement in developing or redeveloping the community's open space and recreation plan
- 2. Strive to involve various community/civic organizations in the planning process of park and recreational developments in the community.
- 3. Strive to involve property owner



MEMORIAL PARK AND DON FRIES RECREATION AREA



PARK TYPE Neighborhood Park

Address: 405 Wallace Street

Size: 60.47 acres

Memorial Park is centrally located in the community and underwent a significant transformation in 2004, replacing outdated structures with modern amenities. This multifaceted facility includes illuminated baseball fields, a volleyball court, a basketball court, a children's play area, restrooms, a shelter area, soccer fields, horseshoe pits, an archery range with an elevated platform, and lighted pathways.

The park spans 40 acres of wooded land characterized by ravines, featuring hiking trails, an ice skating area, and a sledding hill. Memorial Park serves as the main recreational venue for the community.

Adjacent to the park is the Don Fries
Recreational Area on the east side, along
with the Combined Locks Civic Center
Campus, which offers additional soccer
fields, a sledding hill, and an ice skating rink.
This area serves as a trailhead for scenic
walks through over 60 acres of forest, with
6.1 miles of walking and hiking trails. The
natural topography also allows for an
amphitheater that has hosted various
musical events.



MEMORIAL PARK PLAN AND RECOMMENDATIONS



Below is a list of recently completed and planned future projects. Cost estimates are provided in present-year (2025) dollars whenever possible. This serves as a guide for planning and budgeting future improvements and enhancements.

Project		Est. Cost		2025		2026		2027		2028	202	2029	Long- Term	
COMPLETED ITEMS														
Reseal basketball court surface	2023													
Epoxy coating on restroom and meeting room floors	2023													
Shelter ceiling and soffit replacement	2022													
Installed LED lighting	2018													
Completed aerial deer survey	2016													
Paint and replace some playground equipment	2015													
FUTURE ITEMS														
Place a barrier on the lower parking lot's west side to protect the playing field.		\$	2,500	\$	2,500									
New service door on shed @ BVH field		\$	1,000	\$	1,000									
Upgrade existing volleyball court		\$	20,000	\$	20,000									
Annual undergrowth cleanup and blowdowns		\$	0	\$	0									
Repair and reseal asphalt walking trails		\$	5,000	\$	5,000									
Phase out wooden benches		\$	3,000			\$	3,000							
Remove and replace falling trees at BVH field		\$	2,500			\$	2,500							
Crossbow specific targets for archery range		\$	5,000			\$	5,000							
New fencing around playground and other fencing maintenance		\$	50,000					\$	50,000					
Upgrade all existing trail and park lighting to LED		\$	50,000							\$ 50,000				
Construct a new grilling area away from current location and building soffit		\$	25,000								\$	25,000		
Upgrade backstops on all three baseball fields to net system		\$	30,000							\$ 30,000				
Install three pickleball courts		\$	300,000										\$ 300,0	
Splashpad		\$	300,000										\$ 300,0	
New retaining wall West of ice rink, front of Civic Center		\$	250,000										\$ 250,0	

All cost estimates are in 2025 dollars



BICYCLE AND PEDESTRIAN TRAILS



EXISTING BICYCLE AND PEDESTRIAN FACILITIES

The Village of Combined Locks has a total of **8.1** miles of unpaved trails and **0.5** miles of paved trails. A shared-use paved sidewalk trail connects County Rd K to the CE trail.

These trails are part of a designated park and off-road system, primarily utilized for walking. They guide users through various parks and woodland areas.

Memorial Park and Don Fries Recreation Area feature an extensive trail system, which includes XX miles of unpaved trails. This system connects to the CE trail, winding through woodlands and alongside Garners Creek.

The CE trail runs along the southern border of Combined Locks. This asphalt trail parallels CTH CE, stretching from Appleton to Kaukauna and is part of the Outagamie County Parks system, covering approximately 5.8 miles. A pedestrian underpass located off Buchanan Road provides a safe crossing beneath CTH CE.

Plans include linking the CE underpass to a new trail that will run parallel to CTH CE on the southern side of the roadway. This trail will connect the Combined Locks Coonen and Locks Grand neighborhoods, offering safe pedestrian and bicycle routes to the village's main community parks and recreation programs.



Walking/Hiking trails								
Park	Distance (miles)							
Memorial Park	6.1							
Van Zeeland Park	0.6							
Lindberg Park	1.2							
Blaese Park	0.2							
Greenway Park	0							
Coonen Park	0.5							
Total Trail Length								

BICYCLE AND PEDESTRIAN TRAILS



BICYCLE AND PEDESTRIAN FACILITY DEFINITIONS

BIKE LANE

A bike lane is a part of the roadway that has been designated by striping, signing, and pavement markings for the preferential or exclusive use of bicyclists.

SIDEWALKS

Sidewalks are a space for pedestrian travel within the public right-of-way that is separated from roadway vehicles. The terrace provides a buffer zone between users and vehicles

SHARED USE PATH

A shared use path is an off-road facility that is exclusively designated for both pedestrians and bicyclists. Typically, these facilities range from 10 to 14 feet wide.

CROSSWALK

Pedestrian roadway facilities should clearly indicate to pedestrians where and when they should cross the street. It is equally important that crosswalks are clearly visible to motorists entering a pedestrian area.

CURB RAMP OUT

Curb ramps are designed to provide accessible routes for entering crosswalks, crossing streets, or accessing bus stops where walkways meet the curb.

PEDESTRIAN REFUGE ISLAND

Pedestrian refuge islands are positioned to provide a waiting area for those who are unable to completely cross the street during a signal crossing phase.

LANDSCAPING AND STREET FURNITURE Landscaping along the street creates a barrier between motorists and pedestrians, visually narrowing the width of the roadways.

LIGHTING

Pedestrian lighting enhances the visibility of pedestrians for drivers, fosters a sense of personal security, highlights potential hazards, and creates dynamic and welcoming streetscapes.

PEDESTRIAN COUNTDOWN TIMERS

Pedestrian countdown timers enhance safety by providing critical information to assist pedestrians in making crossing decisions, often featuring pushbuttons

RAPID FLASHING BEACON

The rapid flashing beacon is a device used with pedestrian warning signs to provide high-visibility, strobe-like warnings to drivers when pedestrians are using a crosswalk.

SIGNED SHARED ROADWAYS

A signed shared roadway, also known as a bike route, is a street or road designated as a preferred path for cyclists.

PAVED SHOULDERS

A paved shoulder is designed for bicyclists next to travel lanes. Its width varies based on the adjacent travel lane and the presence of a rumble strip..

BICYCLE AND PEDESTRIAN TRAILS



This page can include a map from ECWRPC that documents the trail systems within all of Combined Locks. This map will also show proposed bike paths from Buchanan and Kaukauana that potentially connect with an East side of CE trail running from our Underpass out to the proposed new Kaukauna School East of Hwy 55.

